# PLAN SUBMITTAL DATES

SITE PLAN SUBMITTAL 1: APRIL 08, 2020

# 201 N. GREENSBORO

# CARRBORO, NORTH CAROLINA

APPLICANT / CONSULTANTS **OWNER** LANDSCAPE ARCHITECT:

VICINITY MAP

CKE III LLC 16122 MOREHEAD CHAPEL HILL, NC 27517 919-491-1633 **CONTACT: EDWARD LAMMAS** 

DURHAM, NC 27701 919-682-0368

111 WEST MAIN STREET

COULTER JEWELL THAMES PA


CONTACT: JEREMY ANDERSON COULTER JEWELL THAMES PA 111 WEST MAIN STREET DURHAM, NC 27701 919-682-0368 **CONTACT: PRESTON ROYSTER** 

CLINE DESIGN 125 N. HARRINGTON STREET RALEIGH, NC 27603 919-833-6413 CONTACT: CARL WINSTEAD

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> NC BOARD OF EXAMINERS FOR **ENGINEERS AND SURVEYORS** NC BOARD OF LANDSCAPE ARCHITECTS LIC # C-104

BPG Beacon Proper Group

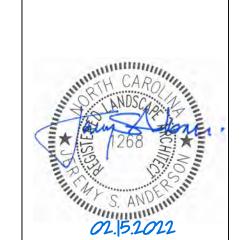

**GREENSBORO** 

201 N Greensboro St.

Carrboro Township, Orange County, North Carolina

9778863587, 9778862555

Job Number 1869 Checked JSA, PR

Revisions 07.24.2020 - COMMENTS 10.13.2020 - COMMENTS 02.15.2022 - COMMENTS

CONDITIONAL USE PERMIT NOT ISSUED

FOR CONSTRUCTION

Sheet Title

Sheet Numbe

COVER SHEET

**SD-0.0** 

# SUMMARY INFORMATION

ACREAGE: 0.33 AC ACREAGE: 0.20 AC

LOTS:

NO CHANGE PROPOSED OVERLAY: DOWNTOWN NEIGHBORHOOD PROTECTION

TOTAL SITE AREA: 23,211 SF / 0.53 AC AREA OF DISTURBANCE:

18,592 SF / 0.43 AC SITE AREA IN 100 YEAR FLOOD PLAIN: 0 AC: FEMA MAP# 3710977800K. EFFECTIVE NOVEMBER 17, 2017

ZONING: B2

B1(C) AND B2

BUILDING DATA: EXISTING BUILDINGS: PROPOSED BUILDINGS:

ZONING: B1(C)

EXISTING

0/0SF 1 / 16,186 SF 42'-0" (45'-4" TO PARAPET)

2.11, 2.12, 2.15, 2.21, 2.22 (RETAIL) 3.1, 3.25 (OFFICE) 5.13, 5.30, 5.40 (CULTURAL AND SOCIAL) 6.11 (ENTERTAINMENT)

VACANT AND PARKING

8.1, 8.2, 8.5, 8.6, 8.7 (RESTAURANT) 18.0 (TOWER AND RELATED STRUCTURES) 19.1 (OPEN AIR MARKET) 27.0 (COMBINATION USES)

1 SPACE PER 400 SF GROSS FLOOR AREA

1 SPACE PER 100 SF GROSS FLOOR AREA

LANDSCAPE SCREENING: REQUIRED

VEHICULAR PARKING:

1 SPACE PER 300 SF GROSS FLOOR AREA 2,500 / 300 = 9 SPACES (JOINT USE PARKING REDUCTION) 9 / 1.2 = 8 SPACES

(JOINT USE PARKING REDUCTION)

25 / 1.2 = 21 SPACES

USE 8.0 (RESTAURANT)

2,500 / 100 = <u>25 SPACES</u> (JOINT USE PARKING REDUCTION) 25 / 1.2 = 21 SPACES

59 MINIMUM SPACES REQUIRED (JOINT USE PARKING REDUCTION) 50 MINIMUM SPACES REQUIRED

PROPOSED:

17 COMPACT (41%) 22 STANDARD

BICYCLE PARKING:

REQUIRED USE 2.1 (RETAIL) 1 SPACE PER 10 AUTOMOBILE SPACES; MIN. 5 = 1 SPACE (8 SPACES / 10 = 1) USE 3.1 (OFFICE) 1 SPACE PER 10 AUTOMOBILE SPACES; MIN. 5 = 3 SPACES (25 SPACES / 10 = 3) USE 8.1 (RESTAURANT) 1 SPACE PER 10 AUTOMOBILE SPACES; MIN. 5 = 3 SPACES (25 SPACES / 10 = 3)

TOTAL 7 SPACES

8 SPACES (4 RACKS) UNCOVERD PROPOSED 6 SPACES (3 RACKS) COVERED (100% OF REQUIRED)

RESOURCE ORDINANCE COMPLIANCE

NO STREAM BUFFERS ON SITE.

EXEMPT FROM TREE COVERAGE (CN TIER)

STEEP SLOPE PROTECTION: NO STEEP SLOPES ON SITE.

WETLANDS PROTECTION: NO WETLANDS ON SITE.

STREAM BUFFERS:

TREE COVERAGE AREA:

FLOODPLAIN PROTECTION: NO FLOOD PLAIN AS PER EFFECTIVE FEMA MAP# 3710977800K (NOVEMBER 17,2017).

TOTAL

1. THIS PROJECT WILL BE COMPLETED WITHIN A SINGLE PHASE.

IMPERVIOUS SURFACE: EXISTING:

PHASING


20,087 sf (0.46 ac) = 86.5% PROPOSED: 20,068 sf (0.46 ac) = 86.5%

# TOWN OF CARRBORO NOTES

- PRIOR TO ISSUANCE OF A ZONING COMPLIANCE PERMIT THE APPLICANT SPECIFICALLY PROVIDE FOR CORRUGATED CARDBOARD RECYCLING, ADDRESSING COMPLIANCE WITH ORANGE REGIONAL LANDFILL CARDBOARD RECYCLING REQUIREMENTS. WITHOUT PROVISION OF ONSITE CARDBOARD RECYCLING
- PRIOR TO ANY DEMOLITION OR CONSTRUCTION ACTIVITY ON THE SITE THE APPLICANT WILL HOLD A DECONSTRUCTION ASSESSMENT CONFERENCE WITH THE COUNTY'S SOLID WASTE STAFF (JEFF SCOUTEN OR MATT TAYLOR 919 968 2788) CONCERNING BUILDINGS TO BE REMOVED FROM THIS SITE
- 3. BY ORANGE COUNTY ORDINANCE, CLEAN WOOD WASTE, SCRAP METAL AND CORRUGATED CARDBOARD, ALL PRESENT IN CONSTRUCTION WASTE, MUST BE
- 4. BY ORANGE COUNTY ORDINANCE, ALL HAULERS OF CONSTRUCTION WASTE MUST BE PROPERLY LICENSED
- PRIOR TO ANY DEMOLITION OR CONSTRUCTION ACTIVITY ON THE SITE THE APPLICANT WILL HOLD A PREDEMOLITION / PRECONSTRUCTION CONFERENCE WITH THE COUNTY'S SOLID WASTE STAFE. THIS MAY BE THE SAME MEETING HELD WITH OTHER DEVELOPMENT OFFICIALS.
- DEVELOPER/OWNER IS REQUIRED TO SCHEDULE AND COORDINATE AN ONSITE PRECONSTRUCTION MEETING PRIOR TO SITE DISTURBANCE WITH
- DEVELOPER/OWNER/CONTRACTOR IS REQUIRED TO CONSTRUCT AND MAINTAIN A CONSTRUCTION ENTRANCE FOR THE PROJECT SITE IN ACCORDANCE WITH ORANGE COUNTY EROSION CONTROL STANDARDS FOR CONSTRUCTION ENTRANCES. ALL MUD, STONE OR OTHER DEBRIS DEPOSITED UPON THE ADJOINING
- ROADWAY SURFACES SHALL BE REMOVED PROMPTLY. MECHANICAL SWEEPING OR WASHING MAY BE REQUIRED. DEVELOPER/OWNER/CONTRACTOR SHALL INSTALL AND MAINTAIN APPLICABLE WORK ZONE SIGNAGE IN ACCORDANCE WITH NCDOT STANDARDS FOR ALL ADJOINING PUBLIC STREET CONNECTIONS OR ACTIVITIES WITHIN A PUBLIC RIGHTOFWAY. SIGNAGE SHALL BE MOUNTED AND SECURED ON SIGNPOST UNLESS
- THE WORK REQUIRES THE USE OF TEMPORARY SIGNAGE THAT IS REMOVED DAILY . ALL CONSTRUCTION VEHICLES, EQUIPMENT AND RELATED MATERIALS CANNOT BE PLACED, STORED AND/OR KEPT WITHIN ANY PORTION OF THE PUBLIC RIGHT
- OF WAY AT ANY TIME. ALL ONSITE MATERIALS SHALL BE SECURED AND CONFINED TO THE LOT UNDER CONSTRUCTION 10. ADD NOTE FOR FINAL PLAT: "NO PLANTINGS EXCEEDING A MATURE HEIGHT OF 30 INCHES, SHEDS, FENCES OR BUILDING STRUCTURES OR MODIFICATION OR
- ALTERATION OF THE DRAINAGE SYSTEM OR EASEMENT IS NOT PERMITTED WITHOUT APPROVAL FROM THE TOWN OF CARRBORO ZONING DIVISION.
- 11. ALL INSTALLED BMPS MUST BE CERTIFIED BY THE ENGINEER OF RECORD AS CONSTRUCTED PER THE APPROVED CONSTRUCTION PLANS PRIOR TO THE ISSUANCE OF THE CERTIFICATE OF OCCUPANCY AND THAT ASBUILT CONSTRUCTION PLANS WILL BE SUBMITTED TO ORANGE COUNTY.
- 2. SUBMITTAL OF THE TRAFFIC CONTROL PLAN FOR PEDESTRIAN AND BICYCLIST SHALL BE SUBMITTED AT THE CONSTRUCTION PLAN REVIEW STAGE. THE MUTCD(MANUAL ON UNIFORM TRAFFIC CONTROL DEVICES) SHALL BE THE REFERENCED FOR DESIGNING THE WORK ZONE AND REROUTING OF PEDESTRIANS AND BICYCLIST. REFERENCE MUTCD TRAFFIC CONTROL FOR WORK ZONES; CHAPTER 6D.01 TRAFFIC CONTROL FOR PEDESTRIANS AND WORKERS AND

# **GENERAL NOTES**

- 1. TOPOGRAPHIC AND PROPERTY INFORMATION BASED ON SURVEY BY TRIANGLE SURVEYORS DATED JAN 16, 2019
- 2. THIS PROJECT IS SERVED BY EXISTING OWASA PUBLIC WATER AND SEWER IN NORTH GREENSBORD ST
- 3. AN ALL WEATHER TRAVEL SURFACE MUST BE IN PLACE PRIOR TO RECEIVING A BUILDING PERMIT.
- BEFORE THE RELEASE OF A BOND IF SOME FEATURES ARE NOT YET IN PLACE AT THE TIME OF THE **CERTIFICATE OF OCCUPANCY**, MYLAR AND DIGITAL ASBUILTS FOR THE STORMWATER FEATURES OF THE PROJECT. DIGITAL ASBUILTS SHALL BE IN DXF FORMAT AND SHALL INCLUDE A BASE MAP OF THE WHOLE PROJECT AND ALL SEPARATE PLAN SHEETS. ASBUILT DXF FILES SHALL INCLUDE ALL LAYERS OR TABLES CONTAINING STORM DRAINAGE FEATURES. STORM DRAINAGE FEATURES SHALL BE CLEARLY DELINEATED IN A DATA TABLE. THE DATA WILL BE TIED TO HORIZONTAL
- 5. OPERATIONS AND USES ALLOWED BY THIS PROJECT WILL BE PERFORMED IN COMPLIANCE WITH THE "GOOD NEIGHBOR" STANDARDS CONTAINED IN ARTICLE XI. SECTIONS 15161 THROUGH 15169 OF THE TOWN OF CARRBORO LAND USE ORDINANCE
- 6. ANY SIGNAGE SHOWN IS FOR REPRESENTATIONAL PURPOSES ONLY AND ANY PROPOSED SIGNAGE WILL REQUIRE A SIGN PERMIT FROM THE TOWN
- 7. FIRE LANE STRIPING WILL BE COORDINATED WITH THE CARRBORO FIRE MARSHALL PRIOR TO THE ISSUANCE OF THE C.O. PER CHAPTER 12 OF THE
- 8. THE APPLICABLE CODE FOR THIS BUILDING IS THE 2018 NORTH CAROLINA FIRE CODE (NCFC). OR THE MOST CURRENT EDITION IN EFFECT AT THE TIME OF CONSTRUCTION. THE INTERNATIONAL FIRE CODE (IFC) WITH NORTH CAROLINA AMENDMENTS.
- 9. TRASH COLLECTION WILL BE COLLECTED BY THE TOWN OF CARRBORO. THE PLAN PROPOSES A 8 CY MSW DUMPSTER THAT MAY REQUIRE AN INCREASED COLLECTION FREQUENCY. THE FREQUENCY WILL BE DETERMINED DURING NORMAL OPERATION OF THE OVERALL DEVELOPMENT, BUT IT IS ANTICIPATED THAT THE COLLECTION FREQUENCY WILL BEGIN AT TWICE (2X) A WEEK.
- 10. CONCRETE SIDEWALKS ADJACENT TO THE PUBLIC ROW WILL INCLUDE BRICK BORDER TREATMENTS AS OUTLINED IN THE DOWNTOWN DESIGN
- 11. ANY NEW DRIVEWAY WILL REQUIRE A DRIVEWAY PERMIT FROM THE TOWN OF CARRBORO.
- 12. A SEPARATE MASTER SIGN PERMIT WILL BE REQUIRED.

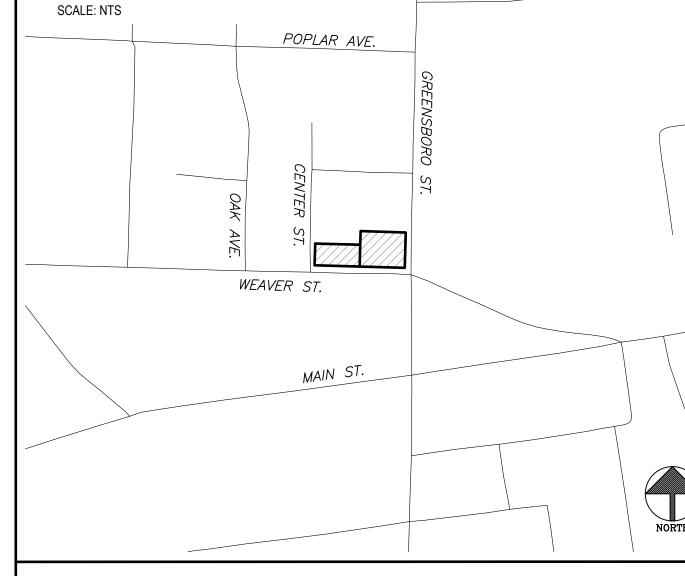

# LIST OF SHEETS

**COVER SHEET SURVEY** 

**EXISTING CONDITIONS AND DEMOLITION PLAN** SD-2.0 SITE PLAN

**EXTERIOR ELEVATIONS** 

GRADING, DRAINAGE, AND EROSION CONTROL PLAN UTILITY PLAN

LIGHTING PLAN SD-7.0 LANDSCAPE PLAN SD-8.0 **DETAILS DETAILS** SD-8.1

SD-8.2 DETAILS

APPROVAL STAMPS

A2.0

# ARCHITECTURAL STANDARDS

- THE PROPOSED THREE STORY BUILDING IS DESIGNED AS A MIXED USE PROJECT WITH THE FIRST FLOOR DEDICATED TO RETAIL FUNCTIONS AND THE UPPER TWO FLOORS FOR BUSINESS/OFFICE. THERE ARE THREE FIRST FLOOR RETAIL BAYS THAT FRONT GREENSBORO STREET. SECTION 15-178.A.1 REQUIRES THAT PRIMARY ENTRANCES ORIENTED TO THE RIGHT OF WAY BE ARTICULATED BY EITHER A DETACHABLE AWNING OR A RECESS. TWO OF THE RETAIL BAYS ALONG GREENSBORO HAVE SUSPENDED AWNINGS AND THE GREENSBORO AND WEAVER CORNER RETAIL BAY HAS AN ENTRY DOOR RECESSED UNDER THE BUILDING CORNER. THE UPPER TWO FLOOR OFFICE AREA IS ACCESSED FROM A LOWER LEVEL LOBBY LOCATED ADJACENT TO THE SURFACE PARKING LOT AT THE BUILDING REAR. THIS ENTRY ALSO HAS AN OVERHEAD AWNING. THE AWNINGS ARE DESIGNED TO BE SUSPENDED BY OVERHEAD CABLES AND EACH RETAIL BAY IS ARTICULATED WITH A
- THE FOLLOWING ARE THE TRANSPARENCY CALCULATIONS FOR THE TWO BUILDING FACADES WITH STREET FRONTAGE: GROUND FLOOR RETAIL TRANSPARENCY: 60%

LEVEL 2/3 TRANSPARENCY: 42% WEAVER STREET GROUND FLOOR RETAIL TRANSPARENCY: 60%

SEE EXHIBIT "A" FOR ADDITIONAL INFORMATION.

LEVEL 2/3 TRANSPARENCY: 42%

6 INCH RECESS FROM THE MASONRY PLANE.

- AS DESIGNED. THE BUILDING PARAPET ELEVATION FACING GREENSBORO AND WEAVER STREETS IS 45'-4" AND THE CORNER BUILDING ELEMENT IS 50'-4". THE BUILDING IS ORIENTED WITH BOTH SOUTH-FACING RIGHT OF WAY (WEAVER STREET) AND AN EAST-FACING (GREENSBORO STREET). AT THE REQUIRED SEPTEMBER 21; NOON SUN PLACEMENT, OF THE AVAILABLE 1,742 SQUARE FEET OF SIDEWALK AREA, 507 SQUARE FEET IS IN THE SHADE FOR A 71% SHADE-FREE AREA. SEE EXHIBIT "B" FOR ADDITIONAL INFORMATION.
- PER THE SUBMITTED SITE PLAN, THE PROPOSED BUILDING OCCUPIES THE CORNER OF GREENSBORO AND WEAVER STREETS. SURFACE PARKING FOR THE PROJECT IS LOCATED WITH ACCESS FROM WEAVER STREET. THE PARKING AREA IS SCREENED FROM GREENSBORO STREET BY THE PROPOSED BUILDING. THE SECTION OF THE SURFACE PARKING AND PROPERTY IS SCREENED WITH LANDSCAPING FOR THE BALANCE OF WEAVER STREET THAT IS NOT OCCUPIED BY THE BUILDING.
- THE PROPOSED BUILDING IS 59'-2-1/2" WIDE. ALONG THE WEAVER STREET FRONTAGE THE LONGEST FACADE IS 33'-0". TWO ADDITIONAL SETS OF BUILDING FACADE CHANGES ALONG WEAVER STREET TOTAL 21'-2". IN ADDITION TO THE BUILDING SETBACKS, THE BUILDING FACADES ARE ARTICULATED WITH RHYTHMS OF GLASS AND STOREFRONT PATTERNS, RETAIL BAYS, SUSPENDED AWNINGS, AND INDIVIDUAL ENTRANCES FOR THE VARIOUS RETAIL BAYS THAT HAVE DIRECT ACCESS FROM THE PUBLIC SIDEWALKS. BUILDING MATERIALS ARE PLANNED TO BE VARIED WITHIN THE EXTERIOR ELEVATIONS. ALTHOUGH THE PROPOSED BUILDING HAS A FLAT ROOF, THE PARAPET LINES ARE VARIED TO PROVIDE AN ARTICULATION OF THE BUILDING CORNICE LINES.

ADDITIONALLY THE GREENSBORO STREET FAÇADE IS ARTICULATED WITH BUILDING PLANE CHANGES, STOREFRONT RHYTHM AND MATERIAL CHANGES VERTICALLY AND HORIZONTALLY.

6. THE PREDOMINATE PROPOSED EXTERIOR BUILDING MATERIALS ARE MASONRY AND GLASS. THE CONCEPT ELEVATIONS INDICATE THAT THE UPPER FLOOR FACING GREENSBORO STREET MAY BE EITHER METAL PANEL OR A CONTRASTING MASONRY. THE GREENSBORO/WEAVER STREET CORNER IS A COMBINATION OF METAL PANEL AND GLASS. THE METAL PANEL SYSTEMS WILL UTILIZE A CONCEALED FASTENER SYSTEM AND NOT EXPOSED

# CONDITIONS OF APPROVAL

CARDBOARD WILL BE KEPT SEPARATE FOR RECYCLING AND WILL NOT BE PLACED IN THE GARBAGE DUMPSTER OR RECYCLING CARTS UNDER THE RISK OF BEING CITED OR FINED.

IF MORE THAN 20,000 SQ. FT. IS DISTURBED, A SEDIMENTATION AND EROSION CONTROL PLAN MUST BE SUBMITTED AND APPROVED PRIOR


IF AN OFFSITE SOIL SPOIL OR BORROW SITE IS UTILIZED, THEN THE DISTURBED AREA FOR THE SPOIL/BORROW SITE MUST BE INCLUDED IN

THE LAND-DISTURBANCE PLAN AND PERMIT UNLESS THE SPOIL/BORROW SITE ALREADY HAS A LAND-DISTURBANCE PERMIT.

**EROSION CONTROL NOTES** 

CLEARLY INDICATED LIMITS OF DISTURBANCE ARE SHOWN ON THE GRADING PLAN.

TO THE ISSUANCE OF A EROSION CONTROL PERMIT.

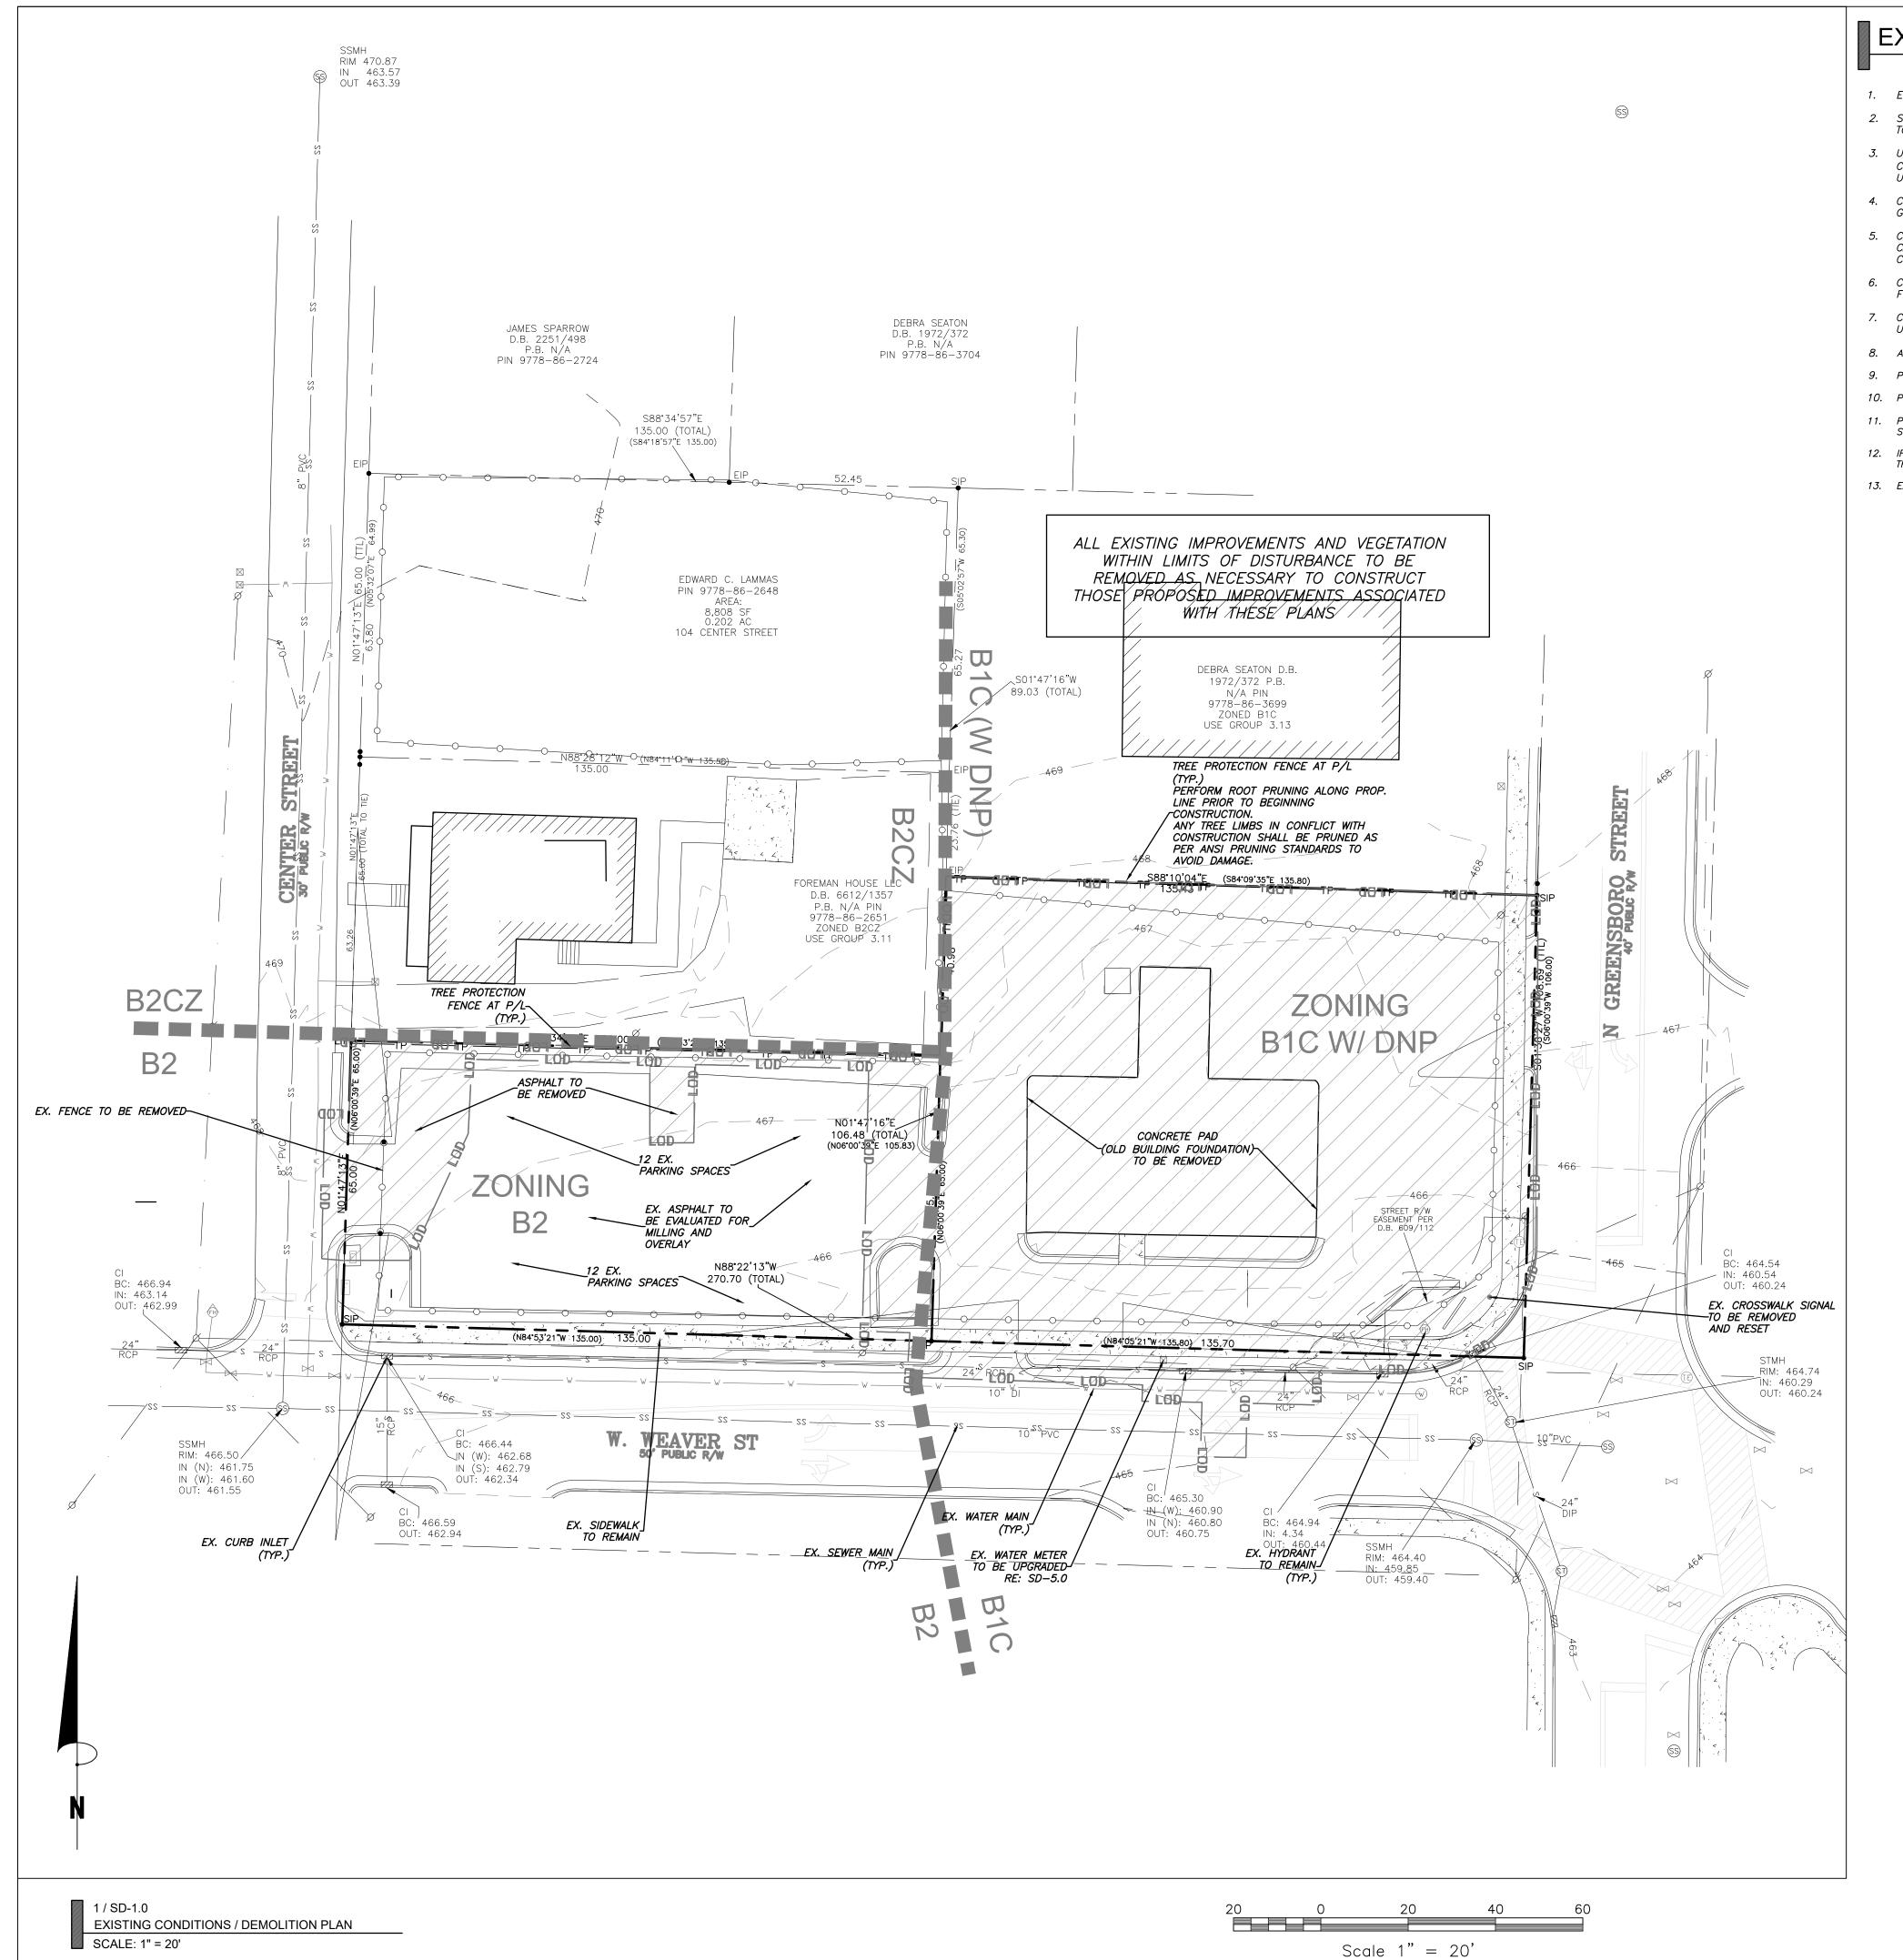

# EXISTING CONDITIONS / DEMOLITION NOTES

- 1. ENSURE ALL EROSION CONTROL MEASURES ARE IN PLACE AND IN WORKING ORDER PRIOR TO THE START OF ANY DEMOLITION AND CONSTRUCTION.
- 2. SEE SITE LAYOUT PLAN C2.0 FOR LAYOUT DIMENSIONS OF EXTENT OF DEMOLISHED AREAS OFFSITE. PAVED AREAS NOT INDICATED TO BE DEMOLISHED, ARE TO REMAIN. ALL CONCRETE SAW CUTS ARE TO BE CLEAN, STRAIGHT AND NEAT.
- 3. UTILITIES: SEE UTILITY PLANS. CONTRACTOR TO COORDINATE WITH UTILITY COMPANIES FOR LOCATION, REMOVAL AND RELOCATION OF ANY UTILITIES.

  CONTRACTOR RESPONSIBLE FOR DETERMINING EXTENT AND LOCATION OF UTILITIES. THIS MAY INCLUDE CONTACTING "NO—CUTS" TO HELP LOCATE SOME
- 4. CONTRACTOR TO ADJUST ALL MANHOLES, VALVES, JUNCTION BOXES, CATCH BASINS, CLEAN—OUTS, ETC., AS NECESSARY TO ACCOMMODATE NEW LAYOUT AND GRADES
- 5. CONTRACTOR RESPONSIBLE FOR OBTAINING ANY PERMITS FOR WORK IN THE NCDOT RIGHTS OF WAY. ANY DAMAGED INFRASTRUCTURE IN THE RIGHT OF WAY CAUSED BY CONSTRUCTION ACTIVITIES MUST BE REPAIRED TO CITY OF DURHAM STANDARDS. THIS INCLUDES, BUT IS NOT LIMITED TO UTILITIES, SIDEWALKS, CURB AND GUTTER, ASPHALT.
- 6. CONTRACTOR RESPONSIBLE FOR REMOVING EVERYTHING WITHIN THE CLEARING LIMITS AND OFF—SITE WORK ZONE INCLUDING TREES, STUMPS, TRASH, FENCING, OR BUILDING MATERIALS.
- 7. CONTRACTOR TO USE CAUTION WORKING AROUND AND NEAR EXISTING STORM, WATER AND SEWER. CONTRACTOR RESPONSIBLE FOR DAMAGE TO EXISTING UTILITIES. DOCUMENT ANY EXISTING DAMAGE WITH OWNER PRIOR TO BEGINNING WORK.
- 8. ALL EXISTING BUILDINGS AND PAVEMENT SHALL BE REMOVED AND/OR REPLACED.
- 9. PER ORANGE COUNTY ORDINANCE, CLEAN WOOD WASTE, SCRAP METAL AND CORRUGATED CARDBOARD, ALL PRESENT IN CONSTRUCTION WASTE, MUST BE RECYCLED.
- 10. PER ORANGE COUNTY ORDINANCE, ALL HAULERS OF CONSTRUCTION WASTE MUST BE PROPERLY LICENSED.
- 11. PRIOR TO ANY DEMOLITION OR CONSTRUCTION ACTIVITY ON THE SITE THE APPLICANT WILL HOLD A PRE-DEMOLITION/PRE-CONSTRUCTION CONFERENCE WITH THE COUNTY'S SOLID WASTE STAFF. THIS MAY BE THE SAME MEETING HELD WITH OTHER DEVELOPMENT OFFICIALS.
- 12. IF EXISTING STRUCTURES ON SITE ARE NOT RELOCATED, A DECONSTRUCTION ASSESSMENT WILL NEED TO BE CONDUCTED BY JEFF SCOUTEN, OCSWM, TO DETERMINE IF THERE ARE MATERIALS THAT CAN BE DIVERTED AWAY FROM THE LANDFILL OR OTHERWISE REUSED.
- 13. EXISTING WATER AND SEWER SERVICE CONNECTION TO BE ABANDONED PER OWASA STANDARDS AND SPECIFICATIONS,




Jewell Thames

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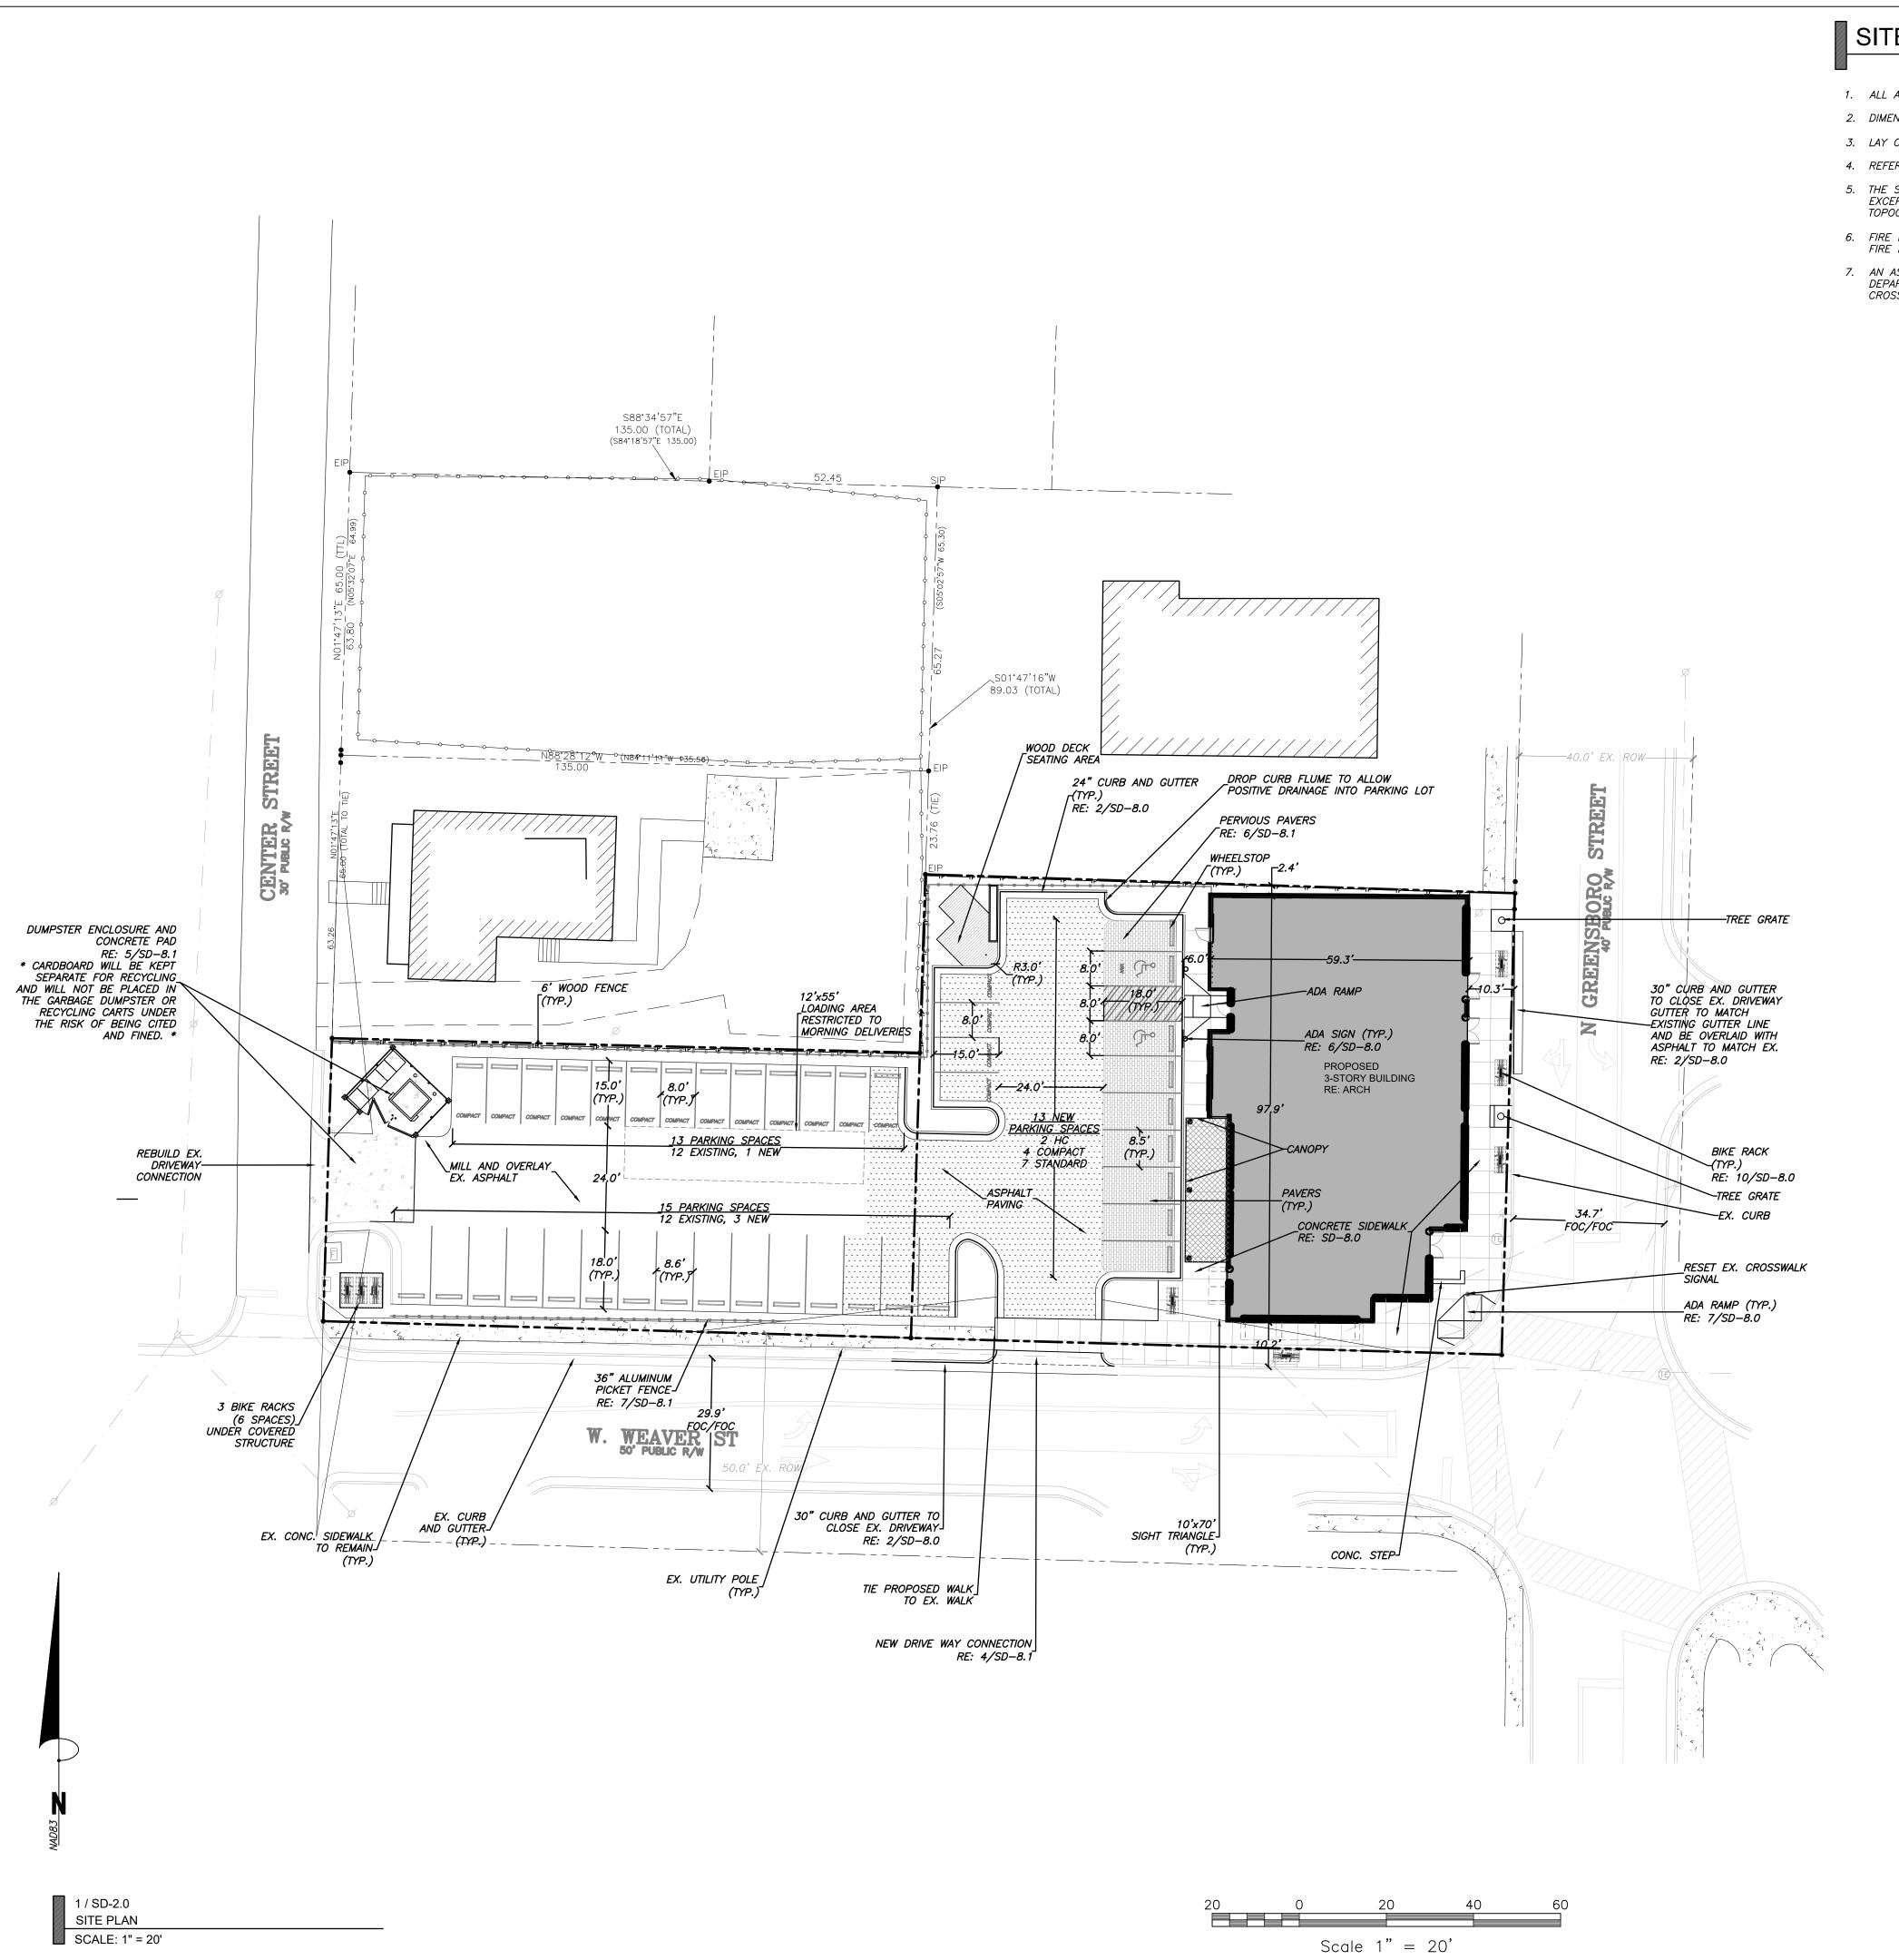
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Sheet Title

EXISTING CONDITIONS/ DEMOLITION PLAN

Sheet Number

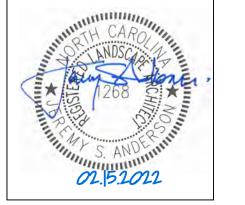**SD-1.0** 



# SITE PLAN NOTES

- 1. ALL ANGLES ARE 90 DEGREES UNLESS OTHERWISE NOTED.
- 2. DIMENSIONS TO BUILDING WALL ARE TO FACE OF WALL AT FINISH GRADE. DIMENSIONS TO CURB ARE TO FACE OF CURB.
- 3. LAY OUT IMPROVEMENTS FOR THE CIVIL ENGINEER'S OR LANDSCAPE ARCHITECT'S REVIEW PRIOR TO BEGINNING CONSTRUCTION.
- 4. REFERENCE ARCHITECTURAL DRAWINGS FOR BUILDING INFORMATION.

2 / SD-2.0

SCALE: 1" = 4'

DUMPSTER PAD DETATIL

- 5. THE SITE WILL BE FULLY COMPLIANT WITH THE NORTH CAROLINA ACCESSIBILITY CODES (ANSI 117.1 —2009 AND CHAPTER 11 OF THE NCBC) UNLESS AND EXCEPT IN AREAS WHERE AN APPROVED STATEMENT FROM A SITE ENGINEER, SURVEYOR OR ARCHITECT VERIFIES THAT SITE CONDITIONS EXIST WHERE THE TOPOGRAPHY OF THE SITE IS EXTREME AND ONLY ALTERNATE METHODS OF COMPLIANCE ARE POSSIBLE.
- 6. FIRE LANES ARE TO BE MARKED IN ACCORDANCE WITH TOWN GUIDELINES (PAVEMENT MARKINGS AND SIGNAGE). FIRE LANE SIGNAGE READING NO PARKING FIRE LANE, WITH RED LETTERS ON WHITE REFLECTIVE BACKGROUND, AND OF STANDARD NO PARKING SIGN CHARACTERISTICS, NEEDS TO BE USED.
- 7. AN AS-BUILT SURVEY OF THE SITE, PERFORMED BY THE DESIGN PROFESSIONAL OR DESIGNEE, MUST BE SUBMITTED TO THE BUILDING INSPECTIONS
  DEPARTMENT CERTIFYING THAT ALL SITE ACCESSIBILITY CODE REQUIREMENTS SUCH AS CURB CUTS, RAMP SLOPES, SIDEWALK SLOPES AND WIDTHS, AND
  CROSS SLOPES MEET THE REQUIREMENTS OF THE NC ACCESSIBILITY CODE PRIOR TO CO ISSUANCE.



Coulter Jewell

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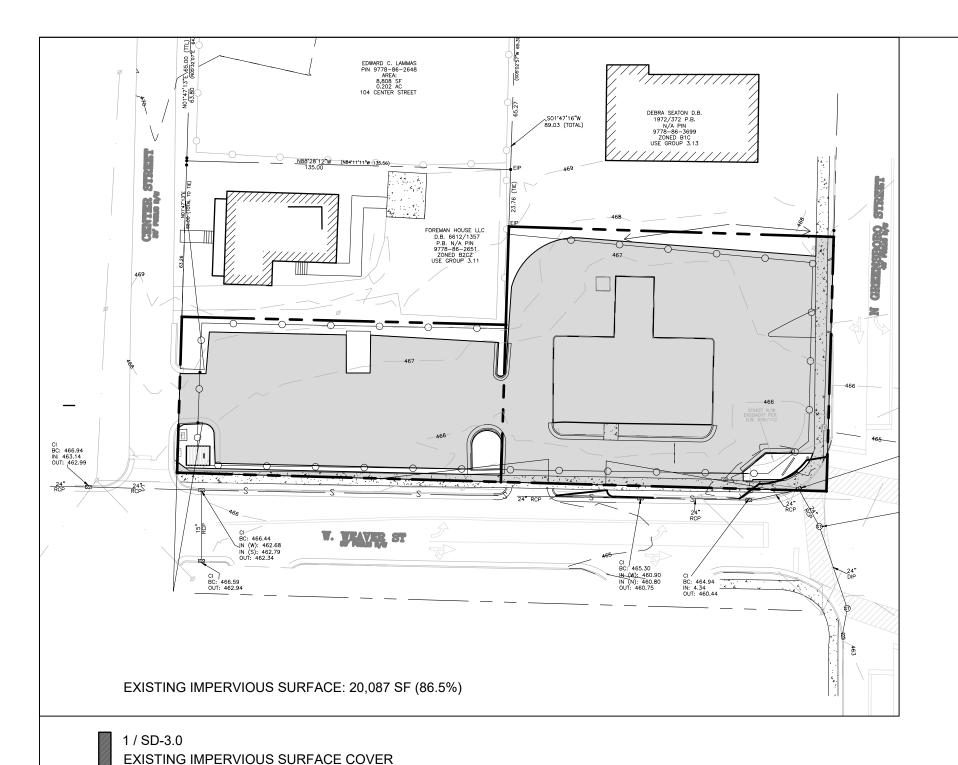
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COMPACT

SITE PLAN

Sheet Number

SD-2.0




GRADING, STORM DRAINAGE, AND EROSION CONTROL PLAN

SCALE: 1" = 20'

# PROPOSED IMPERVIOUS SURFACE: 19,402 SF PROPOSED PERVIOUS PAVERS: 1,332 SF (50% CREDIT) NET IMPERVIOUS SURFACE: 20,068 SF (86.5%)

Scale 1" = 20'

1 / SD-3.0
PROPOSED IMPERVIOUS SURFACE COVER

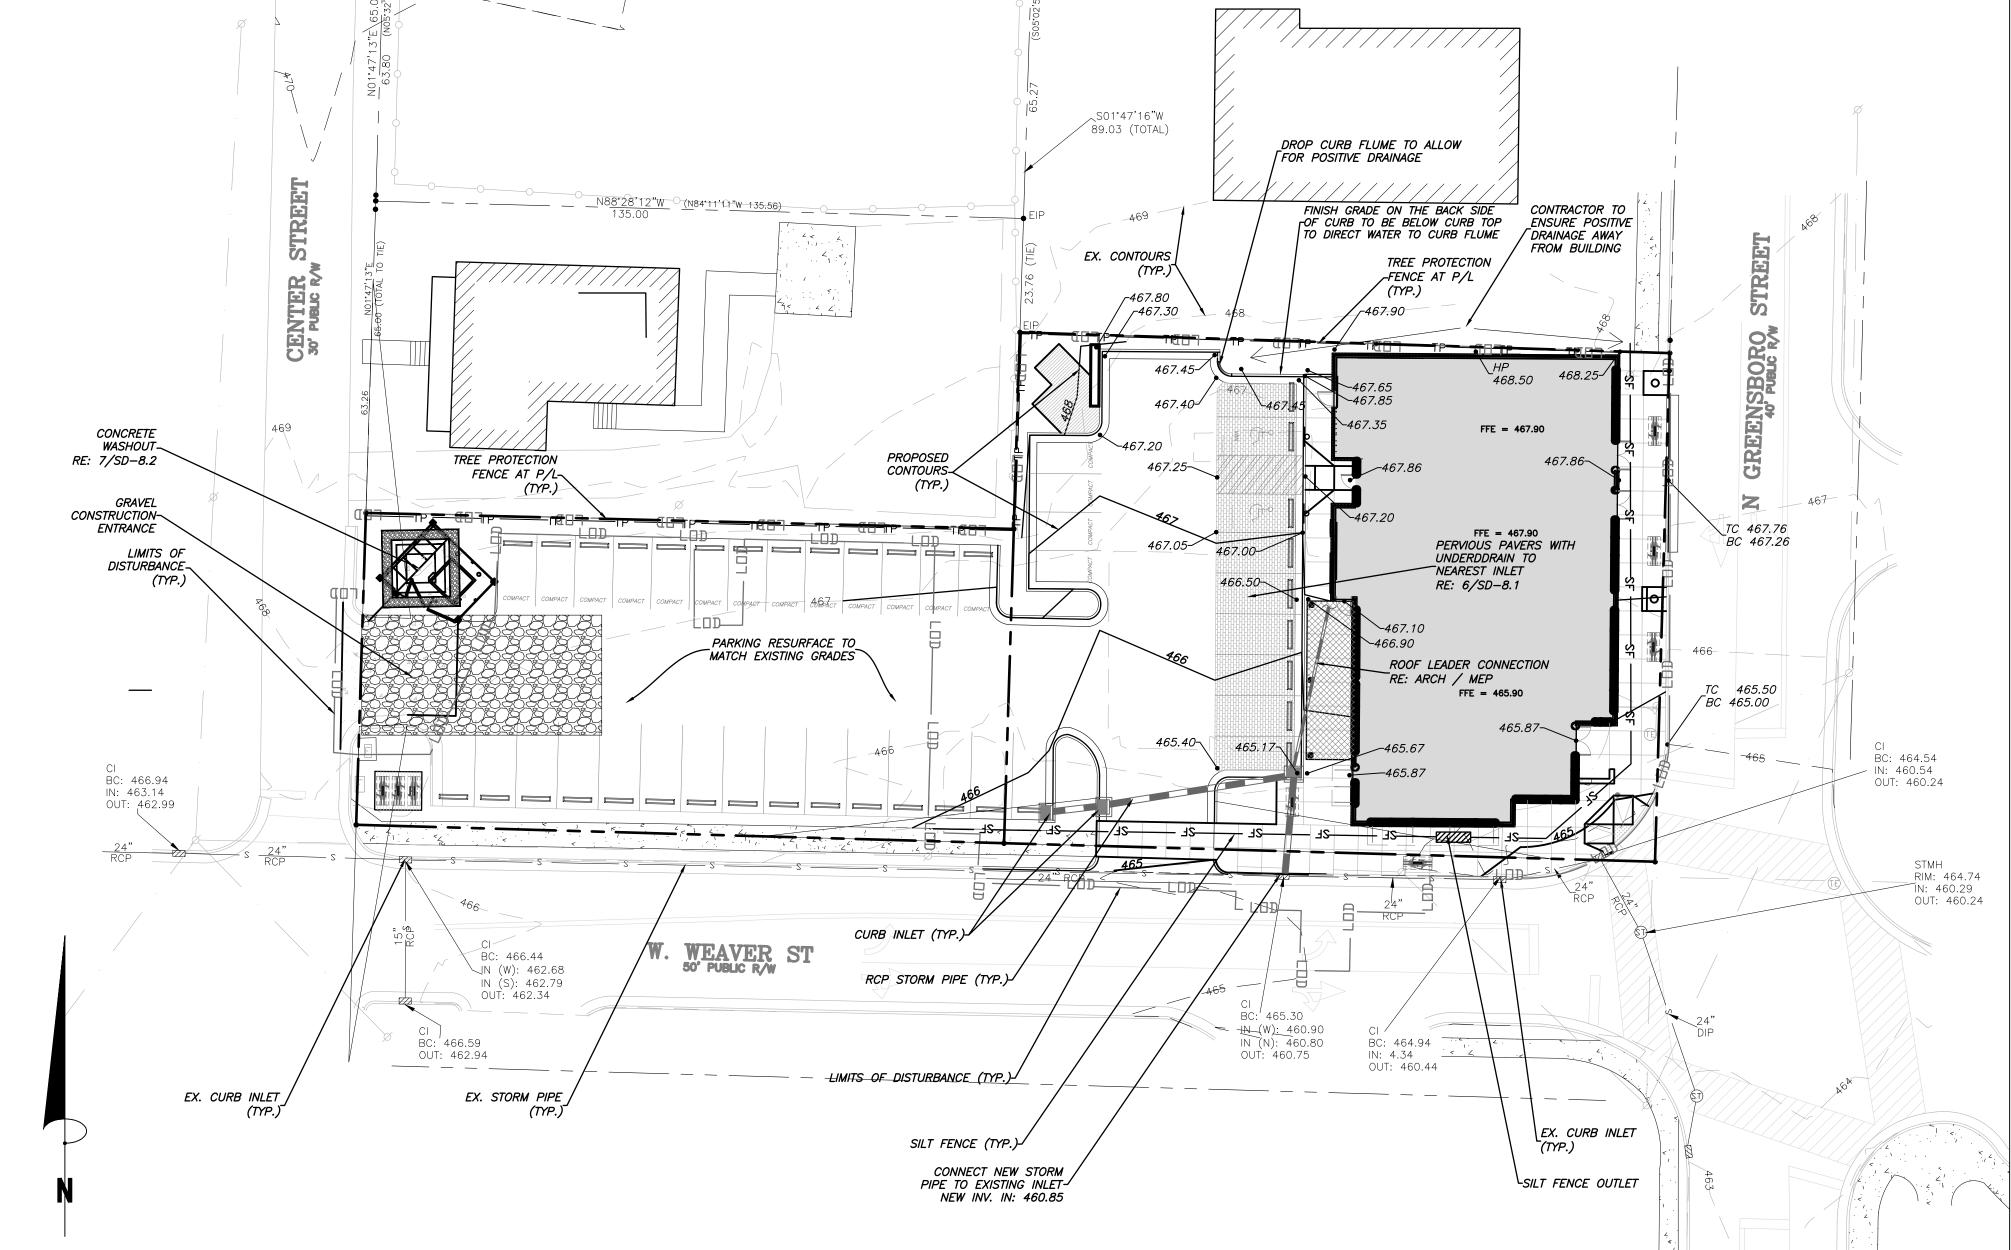

# GRADING & STORM DRAINAGE NOTES

### GRADING NOTES:

1. ALL DIMENSIONS AND GRADES SHOWN ON THE PLANS SHALL BE FIELD VERIFIED BY THE CONTRACTOR PRIOR TO CONSTRUCTION. CONTRACTOR SHALL NOTIFY THE OWNER IF ANY DISCREPANCIES EXIST PRIOR TO PROCEEDING WITH CONSTRUCTION FOR NECESSARY PLAN OR GRADE CHANGES. NO EXTRA COMPENSATION SHALL BE PAID TO THE CONTRACTOR FOR ANY WORK DONE DUE TO DIMENSIONS OR GRADES SHOWN INCORRECTLY ON THESE PLANS IF SUCH NOTIFICATION HAS NOT BEEN GIVEN.

- 2. ALL CONSTRUCTION SHALL BE IN ACCORDANCE WITH THE TOWN OF CARRBORO STANDARDS AND SPECIFICATIONS.
- 3. CONTRACTOR SHALL NOTIFY "NORTH CAROLINA ONE CALL" (1-800-632-4949) AT LEAST 48 HOURS PRIOR TO BEGINNING CONSTRUCTION OR EXCAVATION TO HAVE EXISTING UTILITIES LOCATED. CONTRACTOR TO CONTACT ANY LOCAL UTILITIES THAT PROVIDE THEIR OWN LOCATOR SERVICES INDEPENDENT OF "NORTH CAROLINA ONE CALL".
- 4. PRIOR TO BEGINNING CONSTRUCTION, THE GENERAL CONTRACTOR SHALL SCHEDULE AND ATTEND A PRECONSTRUCTION CONFERENCE WITH THE TOWN OF CARRBORO PLANNING DEPARTMENT AND A REPRESENTATIVE OF THE OWNER.
- 5. CONSTRUCTION, MAINTENANCE AND REMOVAL OF ALL EROSION CONTROL DEVICES ARE THE RESPONSIBILITY OF THE GENERAL CONTRACTOR.
- 6. EXISTING UTILITIES AND STRUCTURES SHOWN, BOTH UNDERGROUND AND ABOVE GROUND, ARE BASED ON A FIELD SURVEY AND THE BEST AVAILABLE RECORD DRAWINGS. THE CONTRACTOR SHALL VERIFY FIELD CONDITIONS PRIOR TO BEGINNING RELATED CONSTRUCTION. ANY DISCREPANCIES SHALL BE REPORTED TO THE OWNER'S REPRESENTATIVE IMMEDIATELY.
- 7. SOIL UNDER BUILDING PAD, PAVED AREAS AND WITHIN SLOPES GREATER THAN 3:1 (H:V) SHALL BE APPROVED, PLACED AND COMPACTED AS RECOMMENDED BY THE GEOTECHNICAL ENGINEER. THESE SOILS SHALL BE COMPACTED AS SPECIFIED UNLESS OTHERWISE RECOMMENDED BY THE GEOTECHNICAL ENGINEER. ANY UNDERCUT OF SOILS IN THESE AREAS SHALL BE APPROVED BY THE GEOTECHNICAL ENGINEER & OWNER. THE UNDERCUT SOILS SHALL ALSO QUANTIFIED BY THE GEOTECHNICAL ENGINEER.
- 8. ALL BANKS, SWALES AND FILL SLOPES SHALL BE NO STEEPER THAN 2.5:1 MAXIMUM. CUT SLOPES SHALL BE NO STEEPER THAN 2:1.
- 9. ALL GRADING MUST PRODUCE SURFACE DRAINAGE ADEQUATE TO PREVENT STANDING WATER OR WET LAWN AREAS, AND TO ENSURE THAT ALL STORM WATER FLOWS TO INLETS OR OTHER POINTS OF DISCHARGE.
- 10. ALL SIDEWALKS SHALL BE CONSTRUCTED WITH A MAXIMUM 1.8% CROSS SLOPE IN THE DIRECTION SHOWN ON THE PLAN.
- 12. CONNECT ALL ROOF LEADERS AND DOWNSPOUTS TO STORM DRAINAGE SYSTEM WITH PVC PIPE. SEE ARCHITECTURAL PLANS FOR LOCATIONS.

### STORM DRAINAGE NOTES:

- 1. ALL STORM DRAINAGE PIPES SHOWN ARE TO BE CLASS III REINFORCED CONCRETE (RCP) UNLESS NOTED OTHERWISE.
- 2. ALL STORM DRAINAGE CONSTRUCTION SHALL BE IN ACCORDANCE WITH THE TOWN OF CARRBORO STANDARDS.
- 3. ALL CONCRETE SHALL MEET A MINIMUM 3000 PSI COMPRESSIVE STRENGTH.
- 4. ALL PIPE IN STORM DRAIN STRUCTURES SHALL BE STRUCK EVEN WITH INSIDE WALL.
- 5. ALL PIPE JOINTS SHALL BE MADE WITH PREFORMED JOINT SEALER, WHICH CONFORMS TO AASHTO SPECIFICATION M-198 FOR TYPE B FLEXIBLE PLASTIC GASKETS UNLESS OTHERWISE NOTED.
- 6. THE INTERIOR SURFACES OF ALL STORM DRAINAGE STRUCTURES SHALL BE POINTED UP AND SMOOTHED TO AN ACCEPTABLE STANDARD USING MORTAR MIXED TO MANUFACTURER'S SPECIFICATIONS.
- 7. ALL BACKFILL SHALL BE NON—PLASTIC IN NATURE, FREE FROM ROOTS, VEGETATION MATTER, WASTE CONSTRUCTION MATERIAL OR OTHER OBJECTIONABLE MATERIAL. SAID MATERIAL SHALL BE CAPABLE OF BEING COMPACTED BY MECHANICAL MEANS AND SHALL HAVE NO TENDENCY TO FLOW OR BEHAVE IN A PLASTIC MANNER UNDER THE TAMPING BLOWS OR PROOF ROLLING.
- 8. MATERIALS DEEMED BY THE OWNER'S REPRESENTATIVE AS UNSUITABLE FOR BACKFILL PURPOSES SHALL BE REMOVED AND REPLACED WITH SUITABLE MATERIAL.
- 9. BACKFILLING OF TRENCHES SHALL BE ACCOMPLISHED IMMEDIATELY AFTER PIPE IS LAID. THE FILL AROUND THE PIPE SHALL BE THOROUGHLY COMPACTED TO 95% OF THE MAXIMUM DRY DENSITY OBTAINABLE WITH THE STANDARD PROCTOR TEST. THE TOP EIGHT (8) INCHES SHALL BE COMPACTED TO 100% STANDARD PROCTOR.
- 10. UNDER NO CIRCUMSTANCES SHALL WATER BE ALLOWED TO RISE IN UNBACKFILLED TRENCHES AFTER PIPE HAS BEEN PLACED.
- 11. SEE THE COVER SHEET FOR NOTES REGARDING IMPERVIOUS SURFACE.

# CONSTRUCTION SEQUENCE

### RE CONSTRUCTION


- 1. VERIFY THAT ALL APPROVALS AND PERMITS NECESSARY TO BEGIN AND COMPLETE THE PROJECT ARE IN HAND. APPROVAL AND PERMITS MUST BE OBTAINED PRIOR TO DISTURBANCE SO THAT WORK WILL NOT BE INTERRUPTED OR DELAYED DUE TO THE LACK OF APPROVED PLANS.
- 2. SCHEDULE AND HOLD A PRE-CONSTRUCTION CONFERENCE BEFORE STARTING DEMOLITION, CLEARING OR GRADING WITH THE OWNER, CONTRACTOR RESPONSIBLE FOR GRADING AND EROSION CONTROL, PERSON RESPONSIBLE FOR SUPERVISING IMPLEMENTATION OF THE EROSION CONTROL PLAN, AND THE ORANGE COUNTY EROSION CONTROL INSPECTOR.
- 3. INSTALL A RURAL TYPE MAILBOX ON THE SITE TO HOLD A COPY OF THE APPROVED EROSION CONTROL PLAN AND TO PROVIDE A PLACE FOR THE INSPECTOR(S) TO LEAVE INSPECTION REPORTS, COMPLIANCE NOTICES, ETC. PLACE THE MAILBOX IN A CONVENIENT LOCATION, SUCH AS AT THE ENTRANCE TO THE SITE OR NEXT TO THE CONSTRUCTION TRAILER. EROSION CONTROL PERSONNEL WILL LEAVE CORRESPONDENCE IN THE BOX AND RAISE THE RED FLAG IF PERSONNEL RESPONSIBLE FOR EROSION CONTROL CANNOT BE LOCATED ON THE SITE. SITE PERSONNEL SHOULD CHECK THE BOX DAILY.

# <u>CONSTRUCTION</u>

- 4. INSTALL GRAVEL CONSTRUCTION ENTRANCE.
- 5. INSTALL SILT FENCE. INSTALL INLET PROTECTION AROUND EXISTING INLETS. CLEAR AND DEMO AREAS SHOWN INSIDE OF THE LIMITS OF DISTURBANCE AS NECESSARY TO BEGIN CONSTRUCTION. LIMIT DISTURBANCE TO AREAS NECESSARY FOR CONSTRUCTION ACTIVITIES AT THAT TIME. STABILIZE DISTURBED AREAS AS SOON AS POSSIBLE.
- 6. DEMO EXISTING UTILITIES AS SHOWN AND CONSTRUCT NEW STORM DRAINAGE. INSTALL INLET PROTECTION AROUND NEW INLETS IMMEDIATELY AFTER CONSTRUCTION. SEAL ALL JUNCTION BOXES FROM STORMWATER INTAKE FROM SURFACE. SEAL ANY INLETS TO STORMWATER STRUCTURES NOT PROTECTED BY INLET PROJECTION.
- 7. MINIMIZE THE AMOUNT OF AREA DISTURBED AT ANY ONE TIME.
- 8. IF IT IS DETERMINED DURING THE COURSE OF CONSTRUCTION THAT SIGNIFICANT SEDIMENT IS LEAVING THE SITE DESPITE PROPER IMPLEMENTATION AND MAINTENANCE OF THE APPROVED EROSION CONTROL PLAN, THE PERSON RESPONSIBLE FOR THE LAND DISTURBING ACTIVITY IS OBLIGATED TO TAKE ADDITIONAL PROTECTIVE ACTION.
- 9. INSPECT AND MAINTAIN THE EROSION CONTROL DEVICES SO THEY CONTINUE TO FUNCTION PROPERLY. REFER TO THE INSTRUCTIONS IN THE EROSION CONTROL PLAN FOR SPECIFIC INSTRUCTIONS FOR EACH DEVICE. THE PERSON RESPONSIBLE FOR EROSION CONTROL IS ALSO RESPONSIBLE FOR TAKING THE INITIATIVE IN INSPECTING AND MAINTAINING THESE DEVICES. DO NOT WAIT FOR EROSION CONTROL PERSONNEL TO POINT OUT THE NEED FOR REPAIRS AND MAINTENANCE. KEEP MUD AND DEBRIS OFF THE PUBLIC STREET AT ALL TIMES. IF MUD OR DEBRIS IS TRACKED FROM THE SITE, USE A SHOVEL AND BROOM TO REMOVE IT IMMEDIATELY. IF MUD AND DEBRIS ARE NOT KEPT OFF THE STREET, ENFORCEMENT ACTION (REVOKING THE GRADING PERMIT AND/OR A STOP WORK ORDER) MAY BE TAKEN!!
- 10. PERMANENTLY STABILIZE ALL DISTURBED AREAS. REFER TO SEEDING SCHEDULE FOR TYPES OF STABILIZATION TO BE USED.
- 11. WHEN CONSTRUCTION IS COMPLETED, REMOVE ALL TEMPORARY EROSION CONTROL DEVICES AFTER THE DRAINAGE AREA ABOVE HAS BEEN SUFFICIENTLY BEEN STABILIZED TO RESTRAIN EROSION. REMOVE AND PROPERLY DISPOSE OF ACCUMULATED SEDIMENT AND THE DEBRIS FROM THE DEVICES, AND STABILIZE THE LOCATION.
- 12. ARRANGE A FINAL INSPECTION WITH THE EROSION CONTROL INSPECTOR TO CONFIRM THAT ALL REQUIREMENTS OF THE APPROVED EROSION CONTROL PLAN HAVE BEEN COMPLETED.

# PERMEABLE PAVERS

- 1. SCHEDULE AND HOLD A PRE—CONSTRUCTION CONFERENCE BEFORE STARTING SITE CONSTRUCTION WITH THE OWNER, CONTRACTOR RESPONSIBLE FOR GRADING AND EROSION CONTROL, PERSON RESPONSIBLE FOR SUPERVISING CONSTRCTION OF PERMEABLE PAVERS AND ENGINEER. ALL PERMEABLE PAVEMENT AREAS ARE TO BE CLEARLY MARKED ON THE SITE.
- 2. ENSURE ACCEPTABLE CONDITIONS FOR CONSTRUCTION. ADJACENT AREAS SHOULD BE GRADED TO DRAIN AWAY FROM PAVERS AND SITE SHOULD BE STABILIZED WITH VEGETATION OR OTHER APPROPRIATE COVER TO PREVENT EROSION AND CONTAMINATION WITH SEDIMENTS. NO CONSTRUCTION TRAFFIC IS TO PASS OVER PERMEABLE PAVER SITE DURING INSTALLATION.
- 3. EXCAVATE IN DRY SUBGRADE CONDITIONS AND AVOID EXCAVATING IMMEDIATELY AFTER STORMS WITHOUT A SUFFICIENT DRYING PERIOD. DO NOT ALLOW EQUIPMENT TO CROSS THE PAVEMENT AREA AFTER EXCAVATION HAS BEGUN. OPERATE EXCAVATION EQUIPMENT FROM OUTSIDE THE PAVEMENT AREA OR FROM UNEXCAVATED PORTIONS OF THE AREA USING AN EXCAVATION STAGING PLAN. USE EQUIPMENT WITH TRACKS RATHER THAN TIRES TO MINIMIZE SOIL COMPACTION WHEN EQUIPMENT ON THE SUBGRADE SURFACE IS UNAVOIDABLE. DIG THE FINAL 9 TO 12 IN. BY USING THE TEETH OF THE EXCAVATOR BUCKET TO LOOSEN SOIL AND DO NOT SMEAR THE SUBGRADE SOIL SURFACE. FINAL GRADING OR SMOOTHING OF THE SUBGRADE SHOULD BE DONE BY HAND IF POSSIBLE. MINIMIZE THE TIME BETWEEN EXCAVATION AND PLACEMENT OF THE AGGREGATE.
- 4. TEST SOIL SUBGRADE INFILTRATION RATE BETWEEN EXCAVATION AND PLACEMENT OF AGGREGATE. TESTING TO BE PERFORMED BY AN APPROPRIATELY QUALIFIED PROFESSIONAL. IF TESTING INDICATES THE INFILTRATION RATE THAT PROVIDES A 72—HOUR DRAWDOWN IS NO LONGER POSSIBLE, RIP OR TRENCH SUBGRADE FURTHER TO RESTORE INFILTRATION RATE.
- 5. PLACE GEOTEXTILES AND GEOMEMBRANE (IF APPLICABLE). PLACE CATCH BASINS, OBSERVATION WELLS AND UNDERDRAIN SYSTEM.
- 6. PLACE AND COMPACT AGGREGATE BASE. INSPECT ALL AGGREGATES AND ENSURE THEY ARE FREE OF FINES. REMOVE ANY ACCUMULATED SEDIMENT ON FINISHED SUBGRADE PRIOR TO PLACEMENT, TO ENSURE THEY CONFORM TO PLANS AND SPECIFICATIONS.
- 7. INSTALL EDGE RESTRAINTS AND BARRIERS. ENSURE DESIGN AND INSTALLATION ARE CONSISTENT PRIOR TO PLACEMENT OF BEDDING.
- 8. INSTALL BEDDING AND PAVERS. CONTRACTOR IS TO FOLLOW SPECIFICATIONS AND MANUFACTURER INSTRUCTIONS FOR THE PLACEMENT OF PERMEABLE PAVERS. THE BEDDING COURSE IS TO BE PLACED IN ACCORDANCE WITH MANUFACTURER OR INDUSTRY GUIDE SPECIFICATIONS.

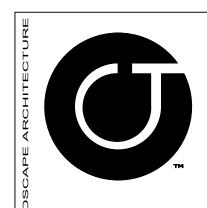


Jewell Thames

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BPG | Beacon Proper Group



201 N. GREENSBORO

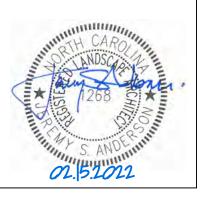201 N Greensboro St.

Carrboro Township, Orange County, North Carolina

PINS: 9778863587, 9778862555

Job Number 1869


CONDITIONAL USE PERMIT NOT ISSUED FOR CONSTRUCTION

Sheet Title

GRADING, STORM DRAINAGE, & EROSION CONTROL PLAN

Sheet Number

SD-3.0

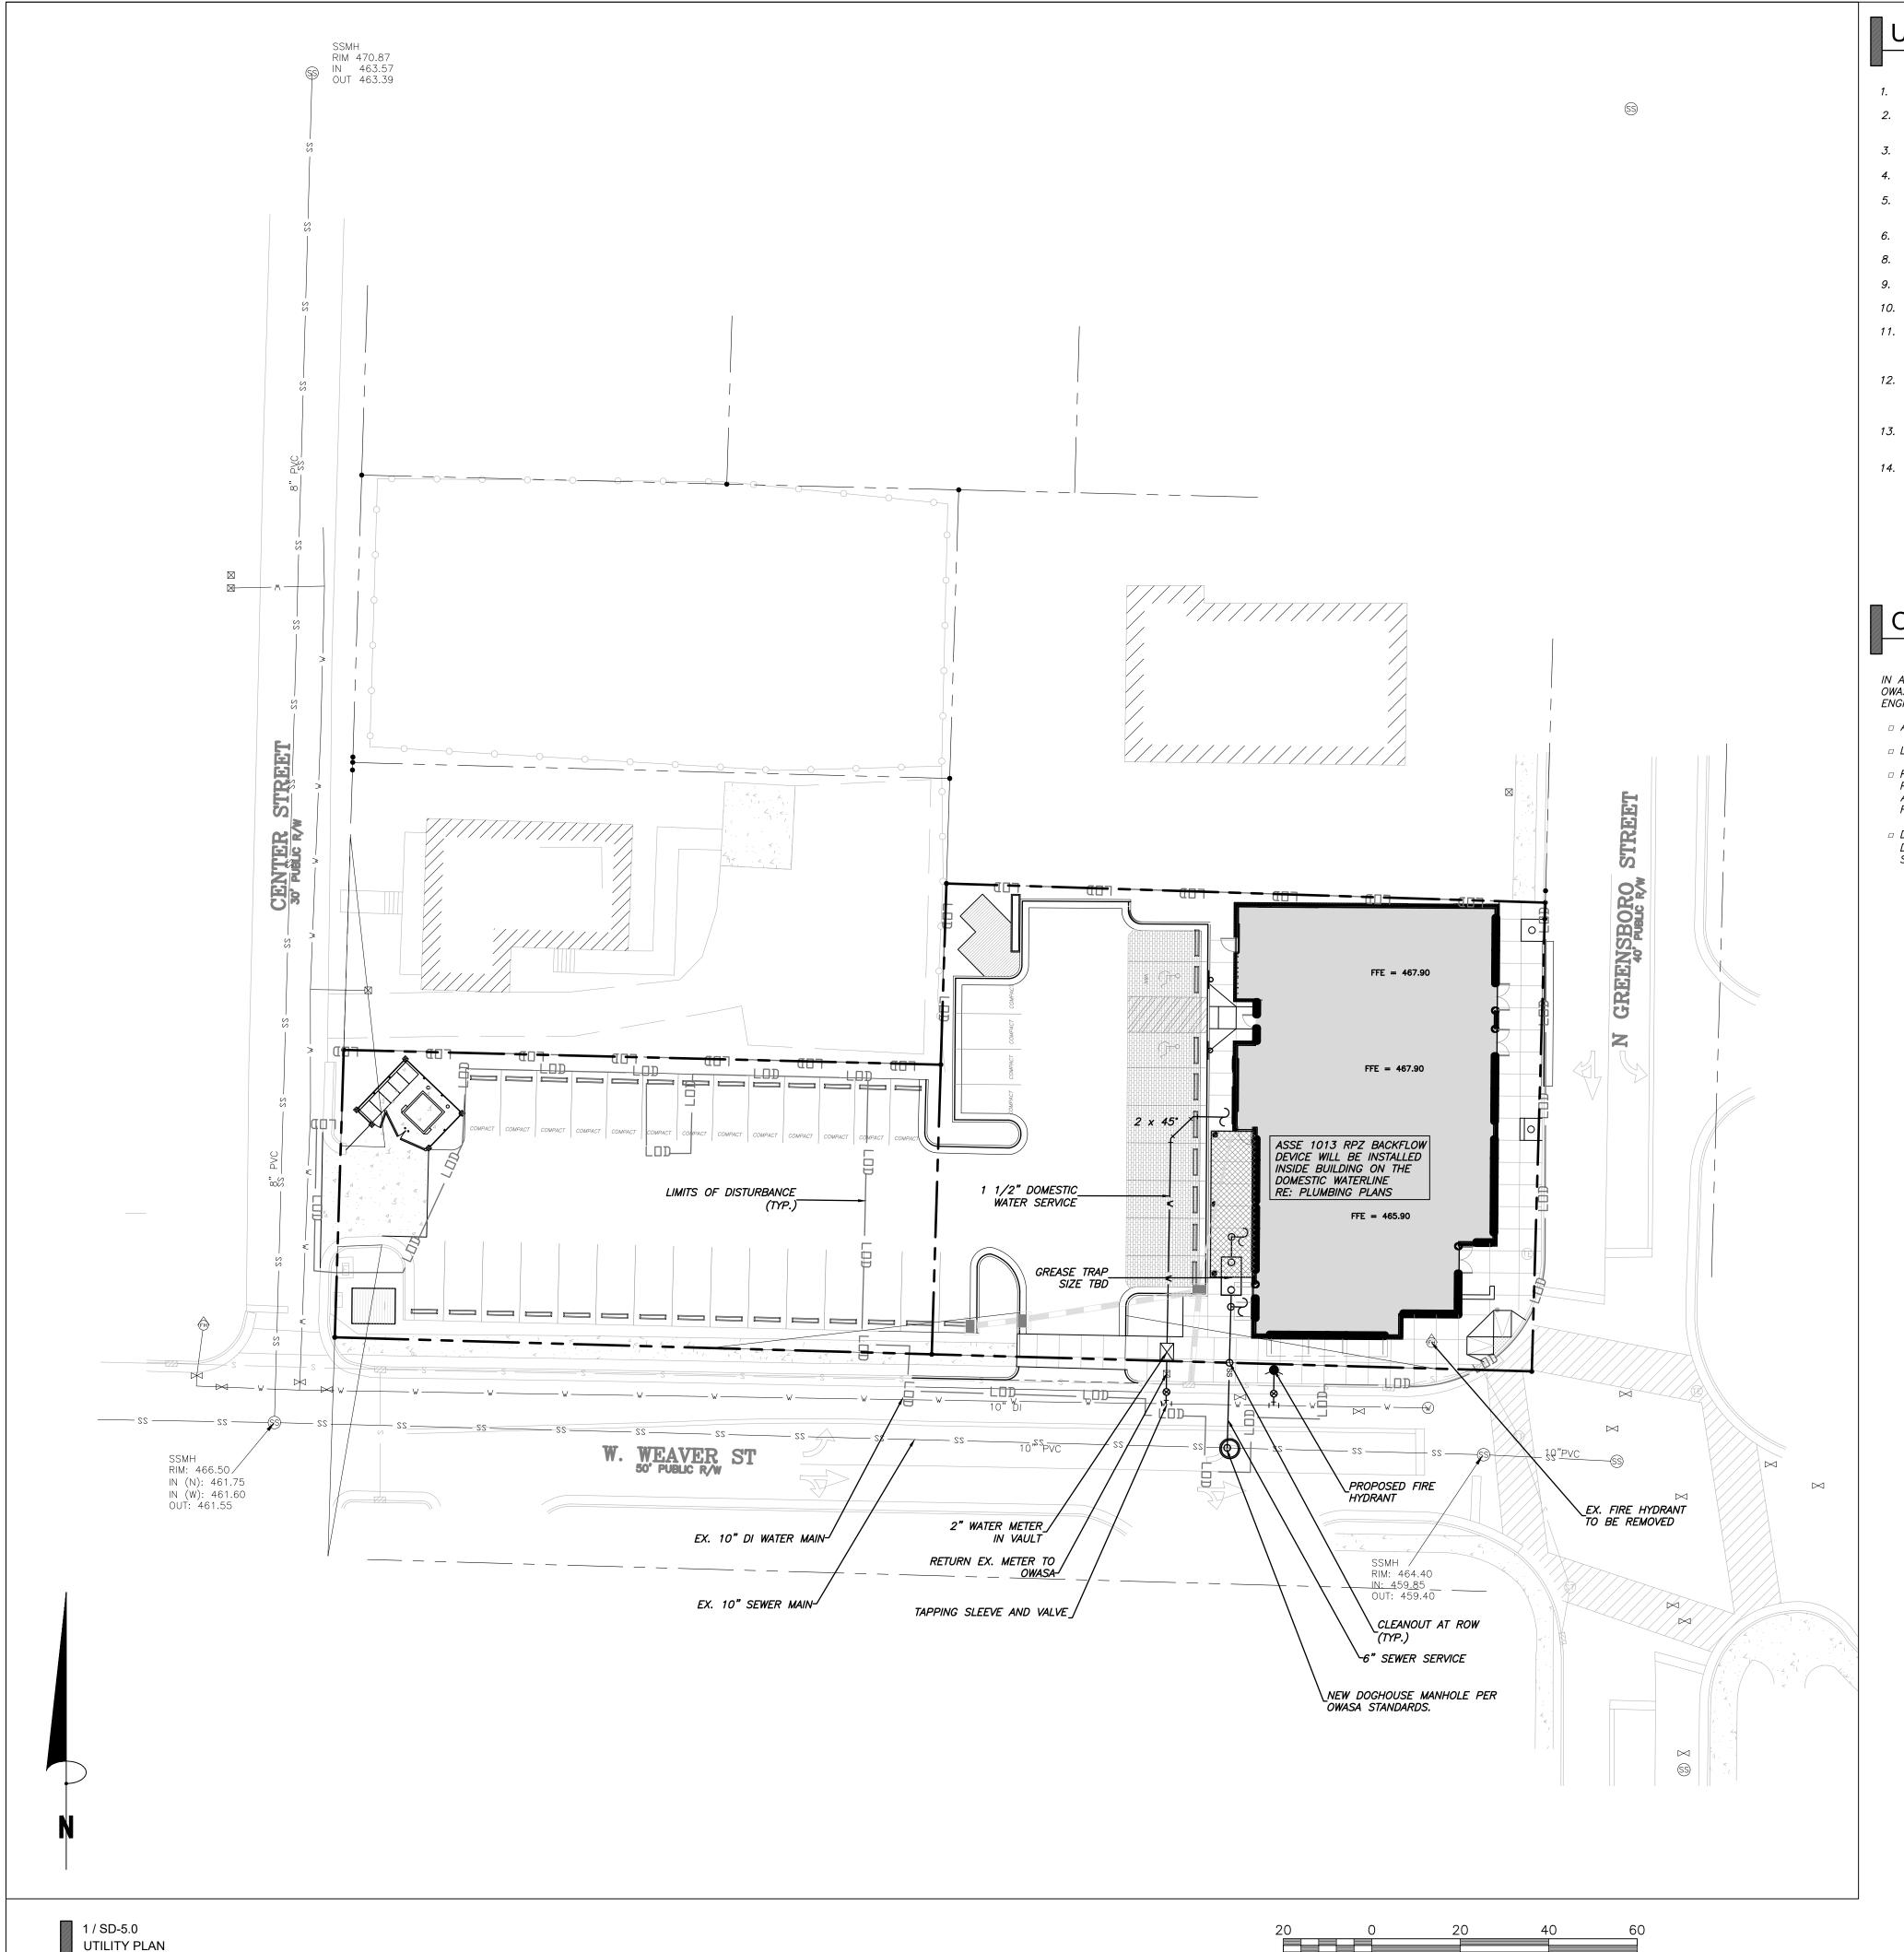

Scale 1" = 20'

SCALE: 1" = 20'

# UTILITY NOTES

- 1. PER SECTION 15-246 OF THE CARBORRO LUO, ALL UTILITIES SHALL BE PLACED UNDERGROUND.
- 2. CONTRACTOR TO FIELD VERIFY ALL EXISTING UTILITY LOCATIONS AND DEPTHS PRIOR TO MOBILIZATION. REPORT THE RESULTS TO THE ENGINEER OF
- 3. ALL UTILITY WORK SHALL CONFORM TO APPLICABLE TOWN, OWASA AND STATE CODES.
- 4. 6" SANITARY SEWER WILL BE INSTALLED AT A MINIMUM SLOPE OF 1.0%. 4" SANITARY SEWER WILL BE INSTALLED AT A MINIMUM SLOPE OF 2.0%.
- 5. CLEANOUTS ON A 4" SANITARY SEWER LATERAL WILL BE INSTALLED AT A MAXIMUM OF 50 FEET APART. CLEANOUTS ON A 6" SANITARY SEWER LATERAL WILL BE INSTALLED AT A MAXIMUM OF 75 FEET APART.
- 6. ALL CLEANOUTS LOCATED IN ASPHALT WILL BE TRAFFIC BEARING AND WILL WITHSTAND A H-20 LOADING.
- 8. ALL WATER AND SEWER LINES ARE TO BE PRIVATE UNLESS OTHERWISE NOTED.
- 9. ALL WATER LINES SHALL HAVE A MINIMUM OF 36" COVER.
- 10. PVC SANITARY SEWER SHALL HAVE A MINIMUM COVER OF 5 FEET IN STREETS AND 4 FEET IN OUTFALLS.
- 11. BACKFLOW PREVENTERS ARE REQUIRED ON THIS PROJECT. BACKFLOW PREVENTER INSTALLER MUST OBTAIN A BACKFLOW PREVENTER PERMIT <u>PRIOR</u> TO BEGINNING BACKFLOW PREVENTER INSTALLATIONS. CONTACT THE CROSS—CONNECTION CONTROL OFFICE AT 919—560—4194 TO OBTAIN ADDITIONAL INFORMATION AND INSTALLATION REQUIREMENTS.
- 12. DOMESTIC BACKFLOW (HIGH HAZARD) INDICATE TYPE, SIZE, AND LOCATION ON DRAWINGS OF DOMESTIC BACKFLOW: REDUCED PRESSURE BACKFLOW ASSEMBLY (RPZ) ASSE #1013 INSTALLED ABOVE GROUND IN AN ASSE #1060 ENCLOSURE OR DIRECTLY INSIDE. WYE STRAINER AND MAIN SHUT—OFF SHALL BE INSTALLED PRIOR TO #1 SHUT OFF OF THE BACKFLOW ASSEMBLY.
- 13. FIRE DEPARTMENT CONNECTION INLET MUST BE ORIENTED 30 DEGREES TOWARDS GRADE AND BE (1) 5 INCH DIAMETER STORZ CONNECTION AND LOCATED ON THE STREET SIDE OF THE BUILDING.
- 14. ALL NEW FIRE HYDRANTS MUST BE PROVIDED WITH (2) 2.5 INCH DIAMETER CONNECTIONS.

# OWASA CLOSEOUT AND DOCUMENTATION CHECKLIST

IN ADDITION TO A FINAL INSPECTION APPROVED BY THE OWASA CONSTRUCTION INSPECTOR, THE FOLLOWING DOCUMENTS MUST BE RECEIVED AND APPROVED BY OWASA BEFORE ACCEPTANCE OF THE PROJECT AND THE SETTING OF METERS. THE FOLLOWING SHALL BE SUBMITTED AS A COMPLETE PACKAGE TO THE OWASA ENGINEERING ASSOCIATE FOR THIRD PARTY REVIEW. PARTIAL SUBMITTALS ARE CONSIDERED INCOMPLETE. ALL INCOMPLETE SUBMITTALS WILL BE RETURNED.

- 🗆 ASSET LETTER SUBMIT ORIGINAL DOCUMENT ON OWASA STANDARD FORM.
- □ LETTER OF DEDICATION SUBMIT ORIGINAL DOCUMENT ON OWASA STANDARD FORM.
- □ RECORD DRAWINGS CONSTRUCTION DRAWINGS SHALL BE MODIFIED TO REFLECT ACTUAL FIELD INSTALLATIONS. ALL DEH
  PUBLIC WATER SUPPLY SECTION PERMITTED EXTENSIONS AND DWQ PERMITTED EXTENSIONS SHALL BE SIGNED AND SEALED BY
  A LICENSED PROFESSIONAL ENGINEER IN THE STATE OF NORTH CAROLINA. SUBMIT THREE COPIES OF THE RECORD DRAWING
  FOR REVIEW BY THE OWASA ENGINEERING STAFF.
- DIGITAL SUBMISSIONS WATER FEATURE DATABASE (MS ACCESS), MANHOLE DATASHEET DATABASE (MS ACCESS), AND RECORD DRAWING (AUTOCAD .DWG FORMAT). CONTACT THE OWASA ENGINEERING TECHNICIANS FOR INFORMATION CONCERNING THIS SUBMITTAL.




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201 N. GREENSBORO

201 N Greensboro St.

Carrboro Township, Orange County, North Carolina

PINS: 9778863587, 9778862555

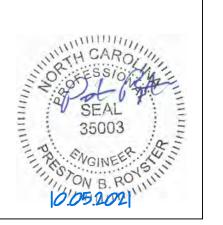 Job Number
 1869

 Drawn
 ED

 Checked
 JSA, PR

 Date
 04.08.2020


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Sheet Title

UTILITY PLAN

Sheet Number

SD-5.0

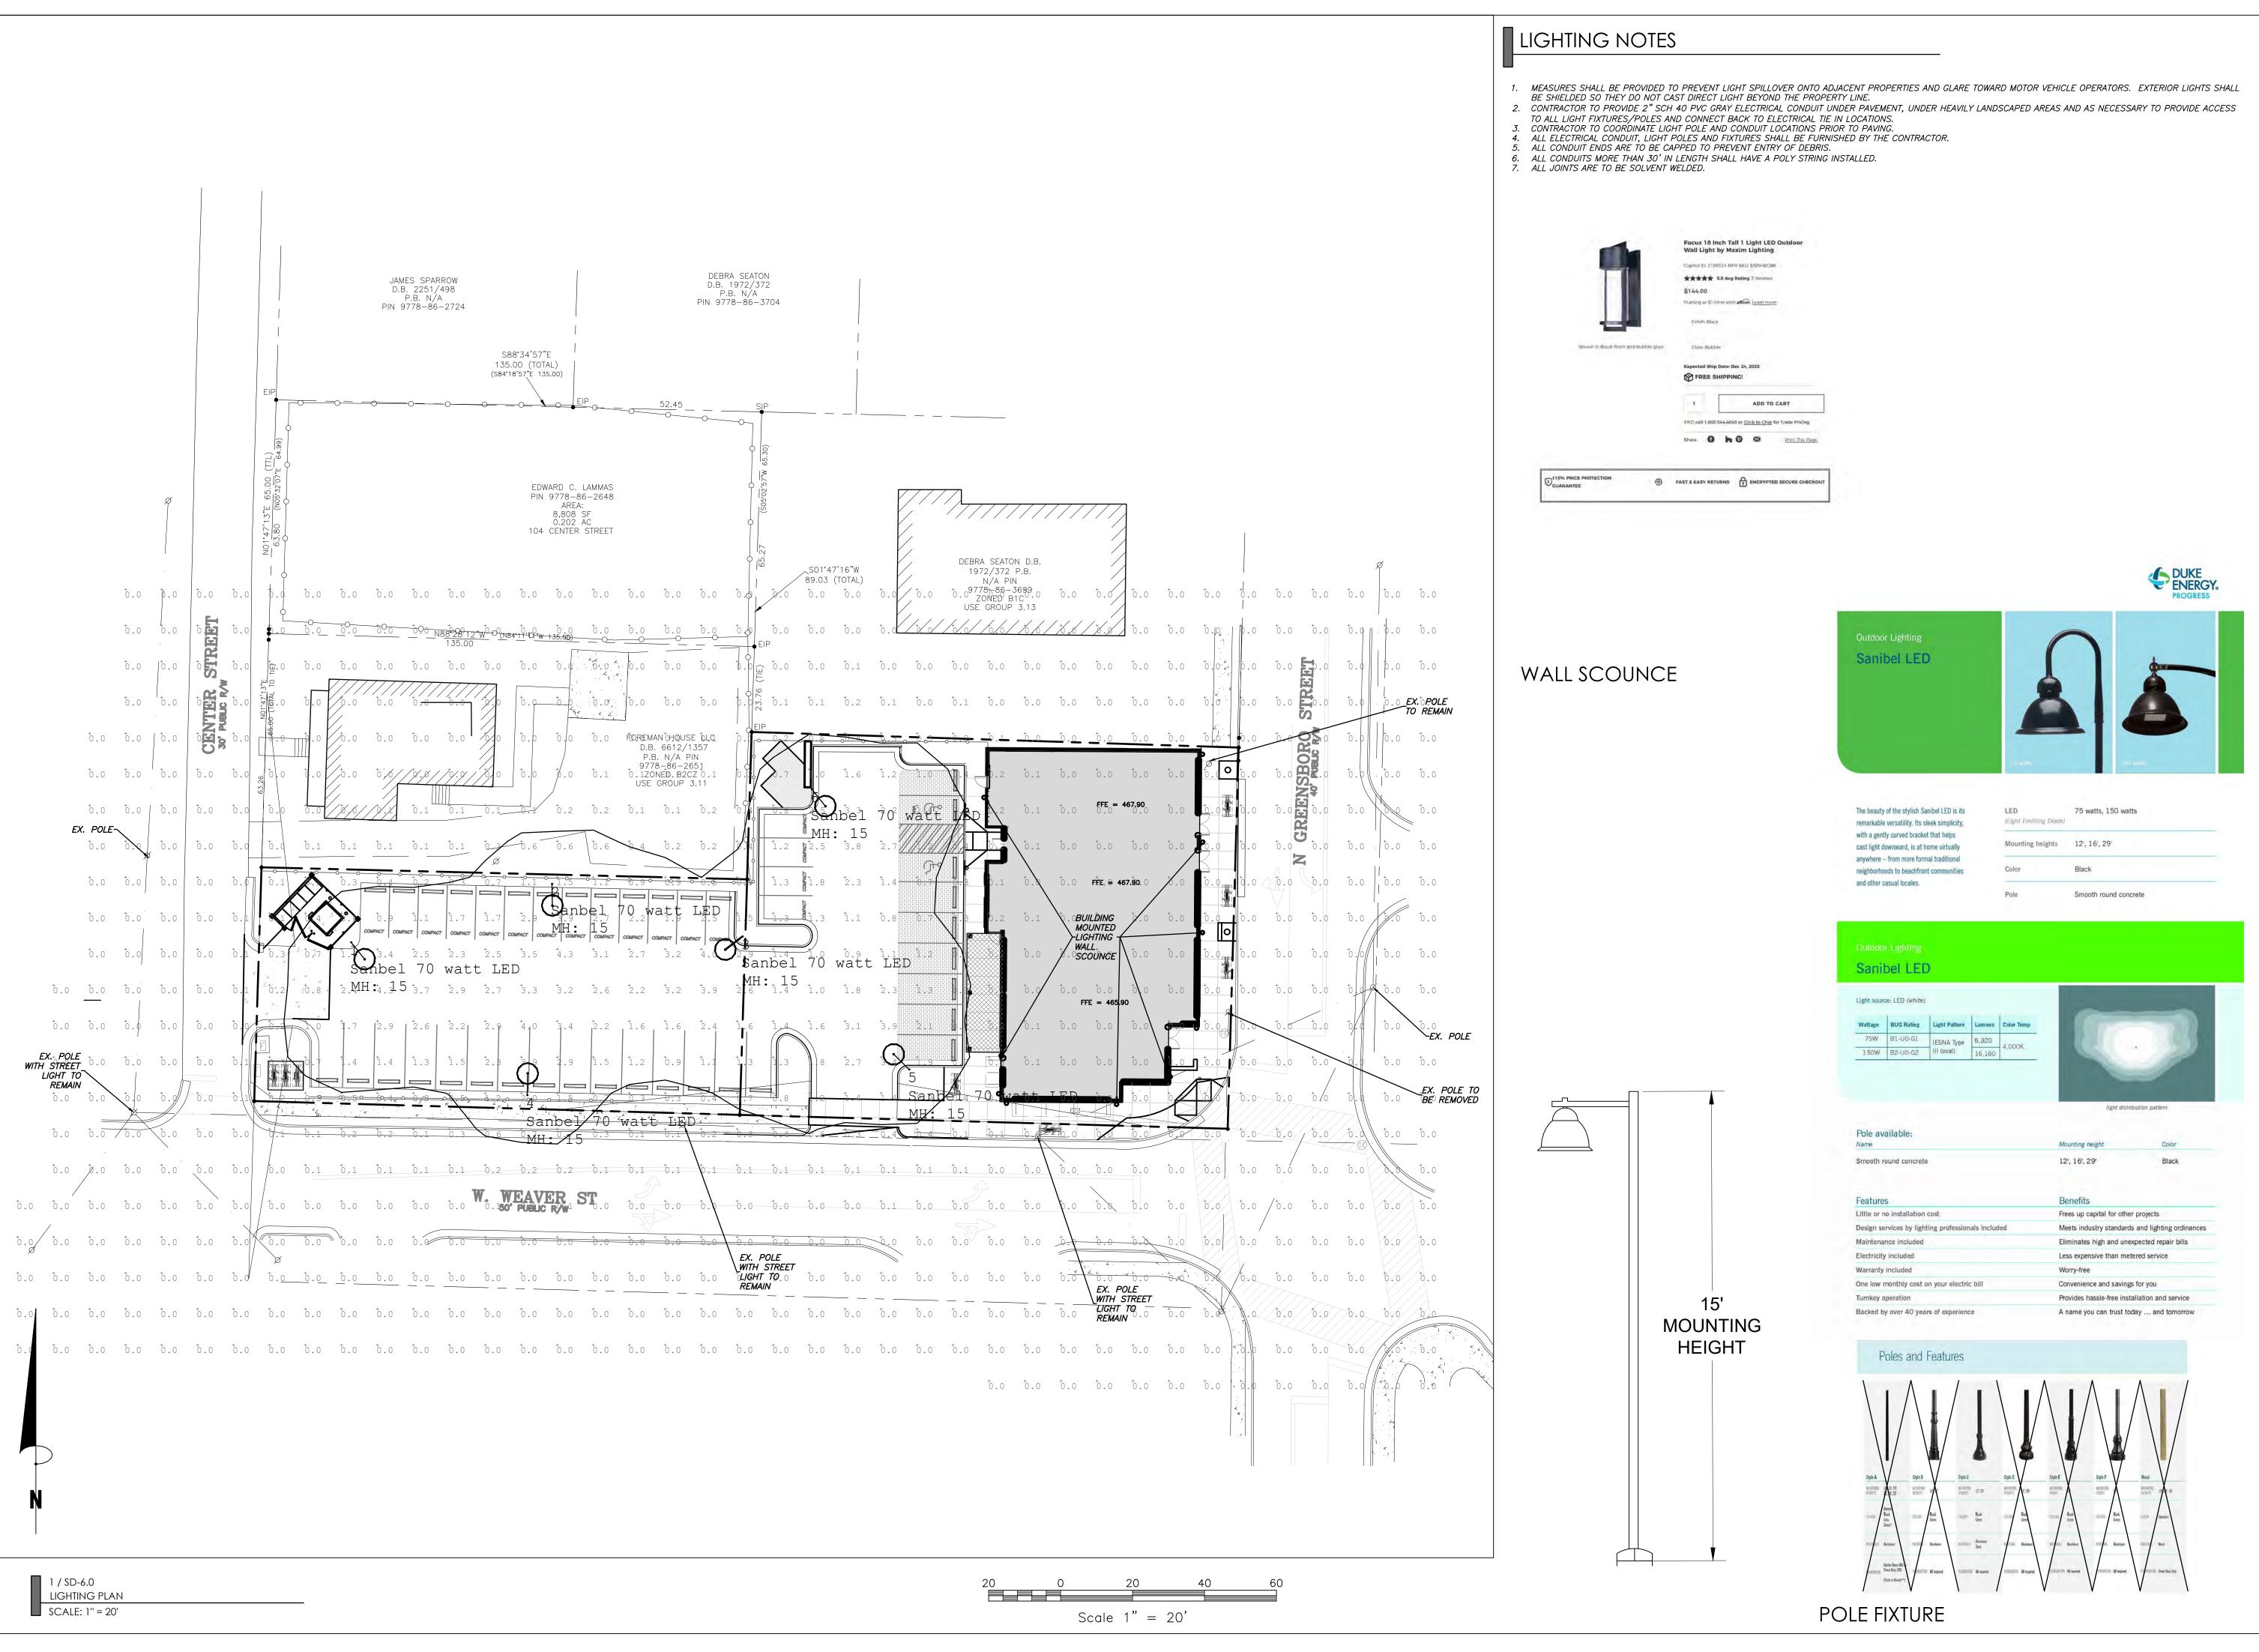

DSCAPE ARCHITECTURE

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Project 201 N. GREENSBORO

201 N Greensboro St.

Carrboro Township, Orange County, North Carolina

PINS:


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Sheet Title

LIGHTING PLAN

Sheet Number

SD-6.0

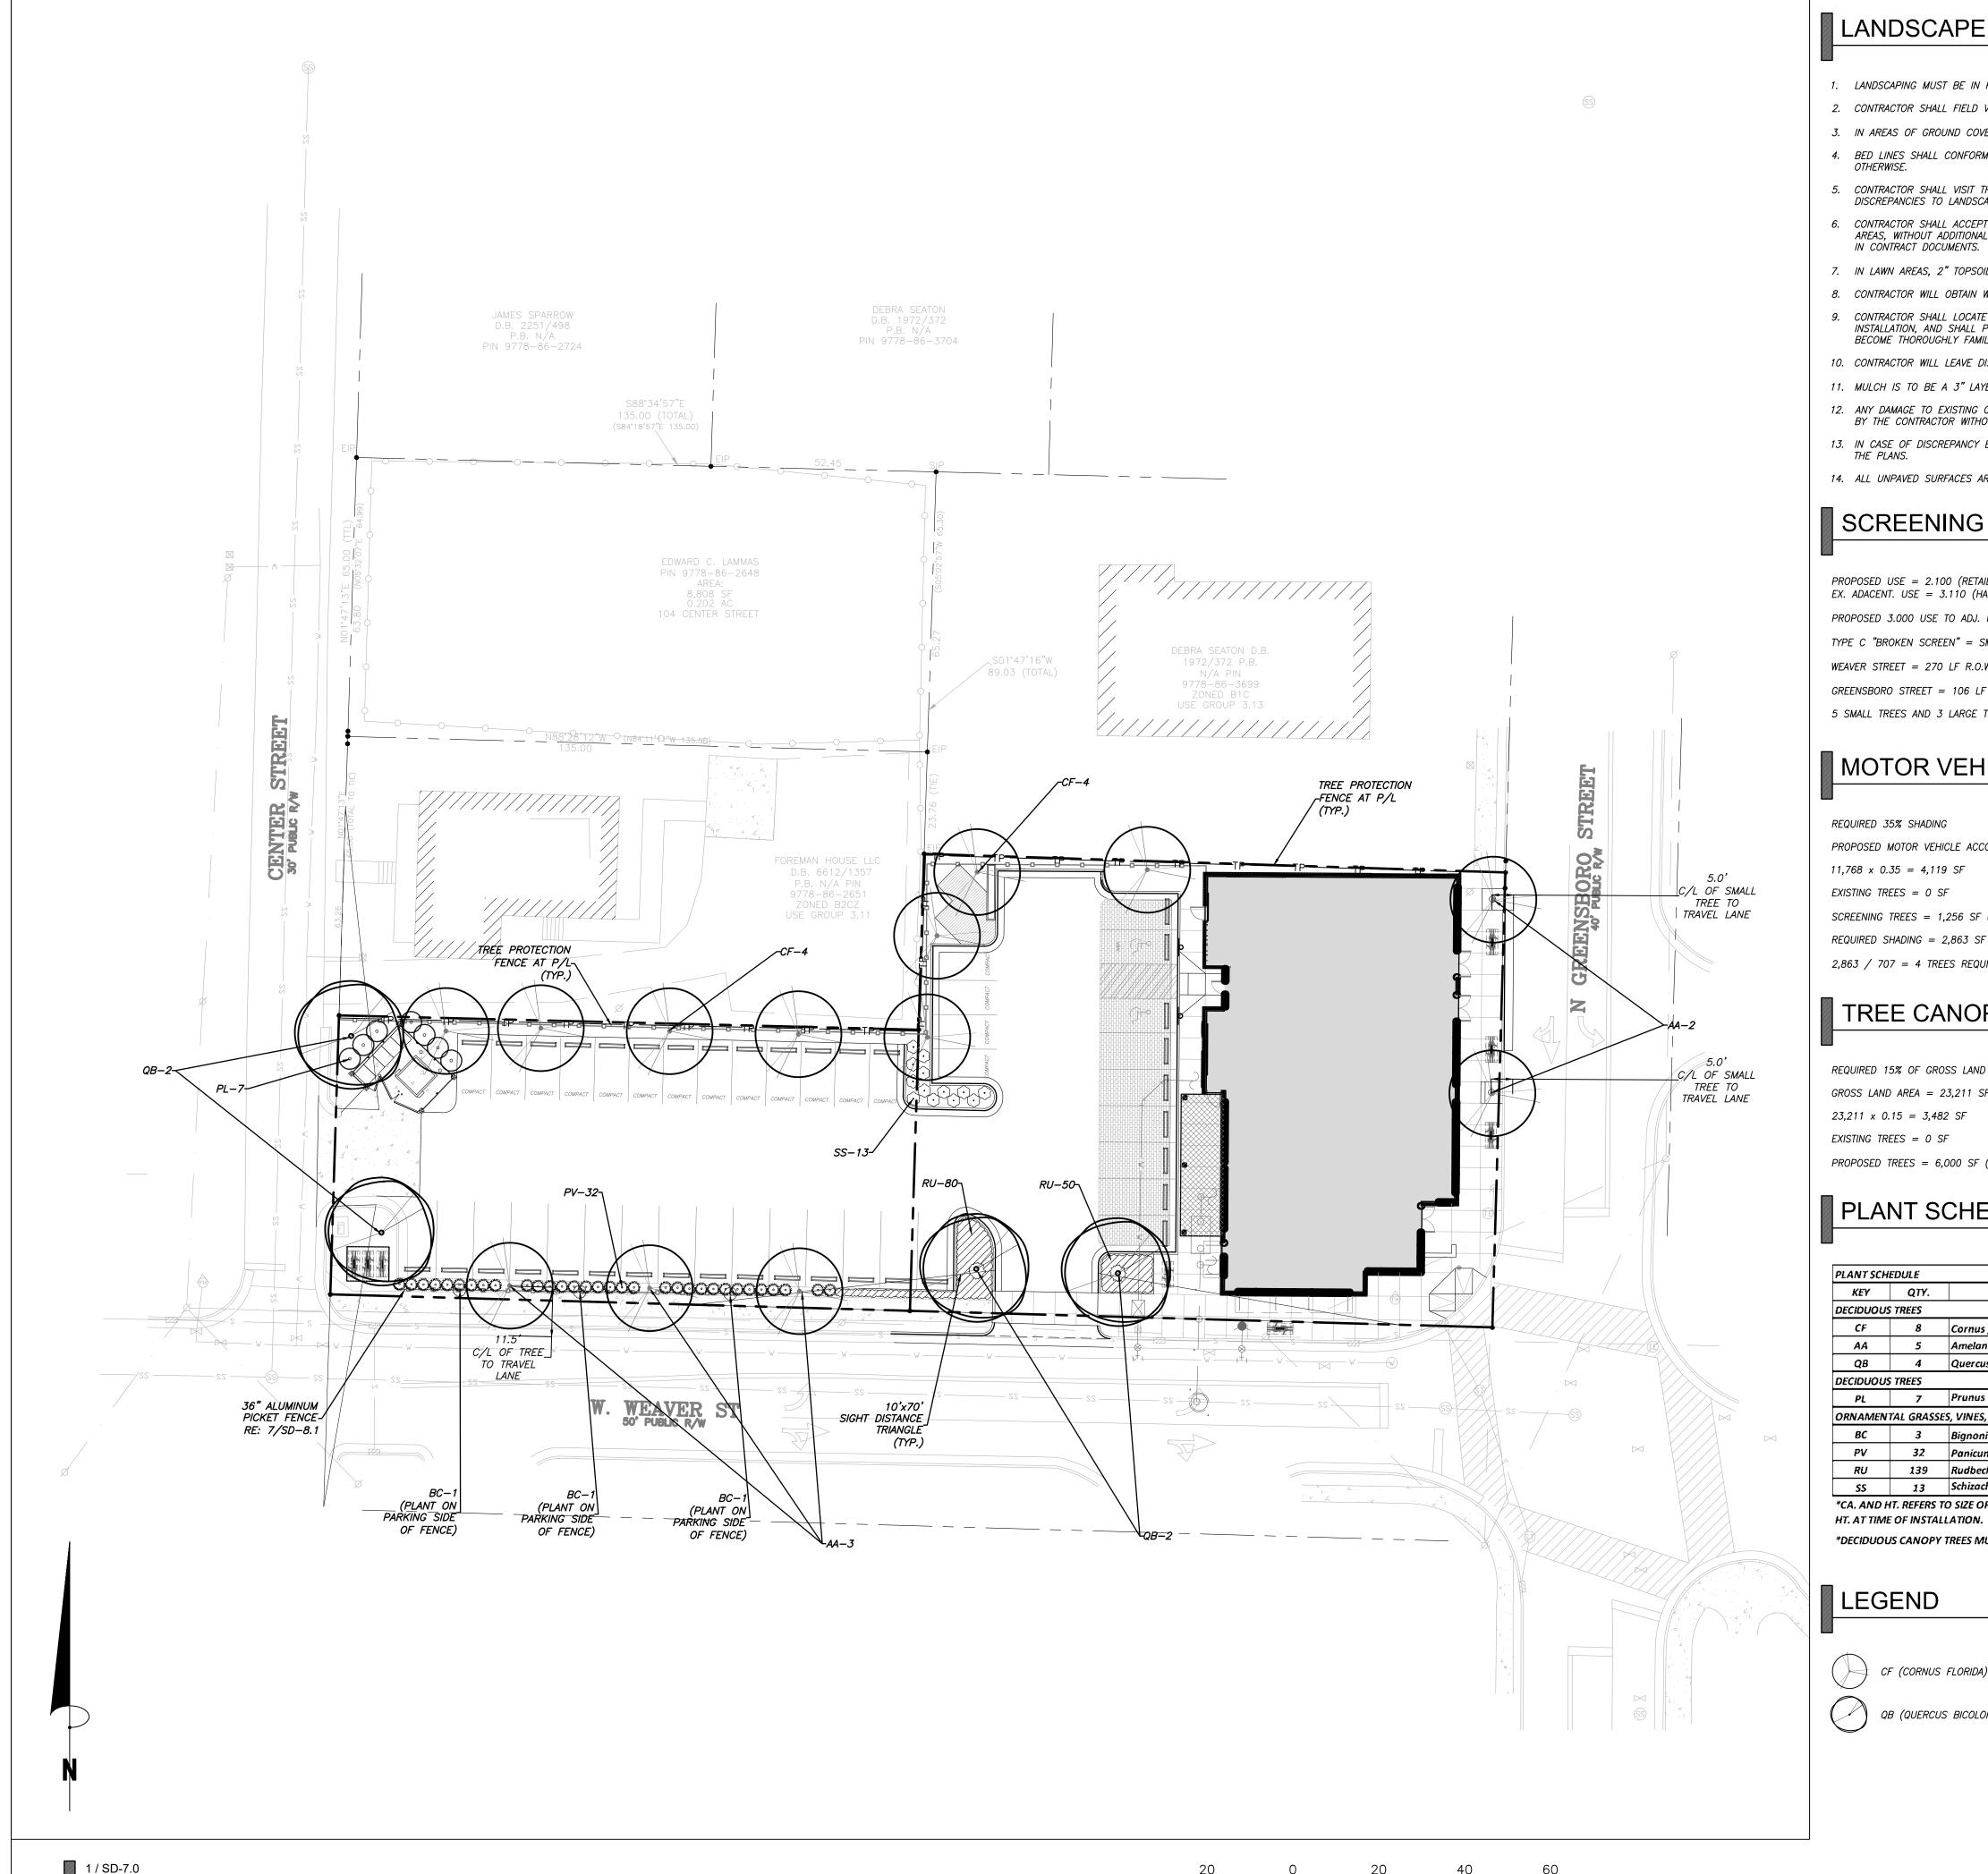

LANDSCAPE PLAN

SCALE: 1" = 20'

# LANDSCAPE NOTES

- 1. LANDSCAPING MUST BE IN PLACE PRIOR TO REQUEST FOR A CERTIFICATE OF OCCUPANCY OR CERTIFICATE OF COMPLIANCE.
- 2. CONTRACTOR SHALL FIELD VERIFY ALL DIMENSIONS, DEPTHS, QUANTITIES, DISTANCES, ANGLES AND SLOPES PRIOR TO ORDERING MATERIALS OR INSTALLING PROJECT.
- 3. IN AREAS OF GROUND COVER, MAINTAIN A 12" MINIMUM DISTANCE BETWEEN PLANTS AND HARD IMPROVEMENTS.
- 4. BED LINES SHALL CONFORM TO CONFIGURATION SHOWN ON THE PLANS. BED LINES SHALL MEET CURBS, WALKS, BUILDINGS, ETC. AT RIGHT ANGLES UNLESS SHOWN
- 5. CONTRACTOR SHALL VISIT THE SITE AND FAMILIARIZE THEMSELVES WITH ACTUAL CONDITIONS AND VERIFY EXISTING CONDITIONS IN THE FIELD. CONTRACTOR SHALL REPORT ALL DISCREPANCIES TO LANDSCAPE ARCHITECT.
- 6. CONTRACTOR SHALL ACCEPT ACTUAL CONDITIONS AT SITE AND PERFORM THE WORK SPECIFIED INCLUDING FINE GRADING AND INCORPORATION OF TOP SOIL INTO PLANTING AREAS, WITHOUT ADDITIONAL COMPENSATION FOR POSSIBLE VARIATION FROM GRADES AND CONDITIONS SHOWN, WHETHER SURFACE OR SUBSURFACE, EXCEPT AS PROVIDED FOR
- 7. IN LAWN AREAS, 2" TOPSOIL SHALL BE TILLED INTO THE TOP 5" OF GROUND PRIOR TO SEEDING.
- 8. CONTRACTOR WILL OBTAIN WRITTEN APPROVAL FROM LANDSCAPE ARCHITECT FOR ANY PLANT SUBSTITUTIONS OF SPECIES, SIZE, OR TYPE OF CONTAINER.
- 9. CONTRACTOR SHALL LOCATE ALL UNDERGROUND UTILITIES PRIOR TO CONSTRUCTION AND SHALL BE RESPONSIBLE FOR THE PROTECTION OF THESE UTILITIES DURING INSTALLATION, AND SHALL PROMPTLY REPAIR AND RESTORE SERVICES AT NO ADDITIONAL COST TO THE OWNER IF DAMAGE OCCURS DURING INSTALLATION. CONTRACTOR SHALL BECOME THOROUGHLY FAMILIAR WITH THE FULL SET OF CONSTRUCTION DRAWINGS AND SPECIFICATIONS FOR COORDINATION WITH UTILITIES, ARCHITECTURAL FEATURES, ETC.
- 10. CONTRACTOR WILL LEAVE DISTURBED AREAS LEVEL AND RAKED SMOOTH, REMOVING ALL ROCKS AND DEBRIS.
- 11. MULCH IS TO BE A 3" LAYER OF TRIPLE SHREDDED HARDWOOD MULCH. MULCH IS TO BE KEPT AWAY FROM TREE TRUNKS.
- 12. ANY DAMAGE TO EXISTING CONDITIONS OUTSIDE THE CONTRACT LIMITS, INCLUDING CURBS, SIDEWALKS, TURF AREAS AND PAVING, SHALL BE RESTORED TO ORIGINAL CONDITION BY THE CONTRACTOR WITHOUT EXTRA COST TO THE OWNER.
- 13. IN CASE OF DISCREPANCY BETWEEN THE QUANTITY OF PLANTS ON THE PLANS COMPARED TO THE PLANT LIST, THE CONTRACTOR SHALL SUPPLY QUANTITIES AS SHOWN ON THE PLANS.
- 14. ALL UNPAVED SURFACES ARE TO BE COVERED IN PLANTS, MULCH, OR GRASS.

# SCREENING CALCULATIONS

PROPOSED USE = 2.100 (RETAIL) AND 3.100 (OFFICE) EX. ADACENT. USE = 3.110 (HAIR SALON) AND 3.130 (DENTISTRY)

PROPOSED 3.000 USE TO ADJ. R.O.W. = TYPE C "BROKEN SCREEN"

TYPE C "BROKEN SCREEN" = SMALL TREES PLANTED 30' ON CENTER

WEAVER STREET = 270 LF R.O.W. - 24' DRIVE AND 55' BUILDING FRONTAGE = 191 LF / 30 = 6 SMALL TREES REQUIRED. 3 SMALL TREES AND 3 LARGE TREES PROVIDED.

GREENSBORO STREET = 106 LF R.O.W. - 99' BUILDING FRONTAGE = 7 LF / 30 = 1 SMALL TREE REQUIRED. 2 SMALL TREES PROVIDED.

5 SMALL TREES AND 3 LARGE TREES PROVIDED

# MOTOR VEHICLE ACCOMMODATION CALCULATIONS

REQUIRED 35% SHADING

PROPOSED MOTOR VEHICLE ACCOMMODATION AREA = 11,768 SF

 $11,768 \times 0.35 = 4,119 \text{ SF}$ 

EXISTING TREES = 0 SF

SCREENING TREES = 1,256 SF (8 SMALL TREES)

REQUIRED SHADING = 2,863 SF

2,863 / 707 = 4 TREES REQUIRED/PROVIDED

# TREE CANOPY COVERAGE CALCULATIONS

REQUIRED 15% OF GROSS LAND AREA

GROSS LAND AREA = 23,211 SF

 $23,211 \times 0.15 = 3,482 \text{ SF}$ 

EXISTING TREES = 0 SF

PROPOSED TREES = 6,000 SF (9 TREES)

# PLANT SCHEDULE

KEY	QTY.	BOTANICAL NAME	COMMON NAME	Cal*	HT*	ROOT	REMARKS
DECIDUOU	S TREES						
CF	8	Cornus florida	Flowering Dogwood	2.5"	-	B&B	Full, Match , Straight lead
AA	5	Amelanchier arborea 'Autumn Brillaince'	Downey Serviceberry	2.5"	-	B&B	Full, Match , Single Stem
QB	4	Quercus bicolor	Swamp White Oak	2.5"	-	B&B	Full, Match , Straight lead
DECIDUOU	S TREES						
PL	7	Prunus laurocerasus 'Schipkaensis'	Schipka Laurel	-	24"	5 gal.	Full, Match , Straight lead
ORNAMEN	TAL GRASS	ES, VINES, & GROUNDCOVER					
вс	3	Bignonia carpeolata	Crossvine	-	-	1 gal.	Full, Match , Straight lead
PV	32	Panicum virgatum	Switchgrass	-	-	3 gal.	Full, Match , Single Stem
RU	139	Rudbeckia 'Goldsturm'	Black-Eyed Susan	-	-	1 gal.	Full, Match , Straight lead
SS	13	Schizachyrium scoparium 'Prairie Blues'	Little Bluestem	*	*	3 gal.	Full, Match , Straight lead

\*DECIDUOUS CANOPY TREES MUST MEET OR EXCEED MINIMUM CALIPER REQUIREMENTS SHOWN ABOVE TO MEET MINIMUM ORDINANCE REQUIREMENTS.

# LEGEND



CF (CORNUS FLORIDA)

QB (QUERCUS BICOLOR)

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Project **GREENSBORO** 

201 N Greensboro St.

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9778863587, 9778862555

Job Number 1869 Checked JSA, PR Revisions 07.24.2020 - COMMENTS 10.13.2020 - COMMENTS 10.05.2021 - COMMENTS 02.15.2022 - COMMENTS

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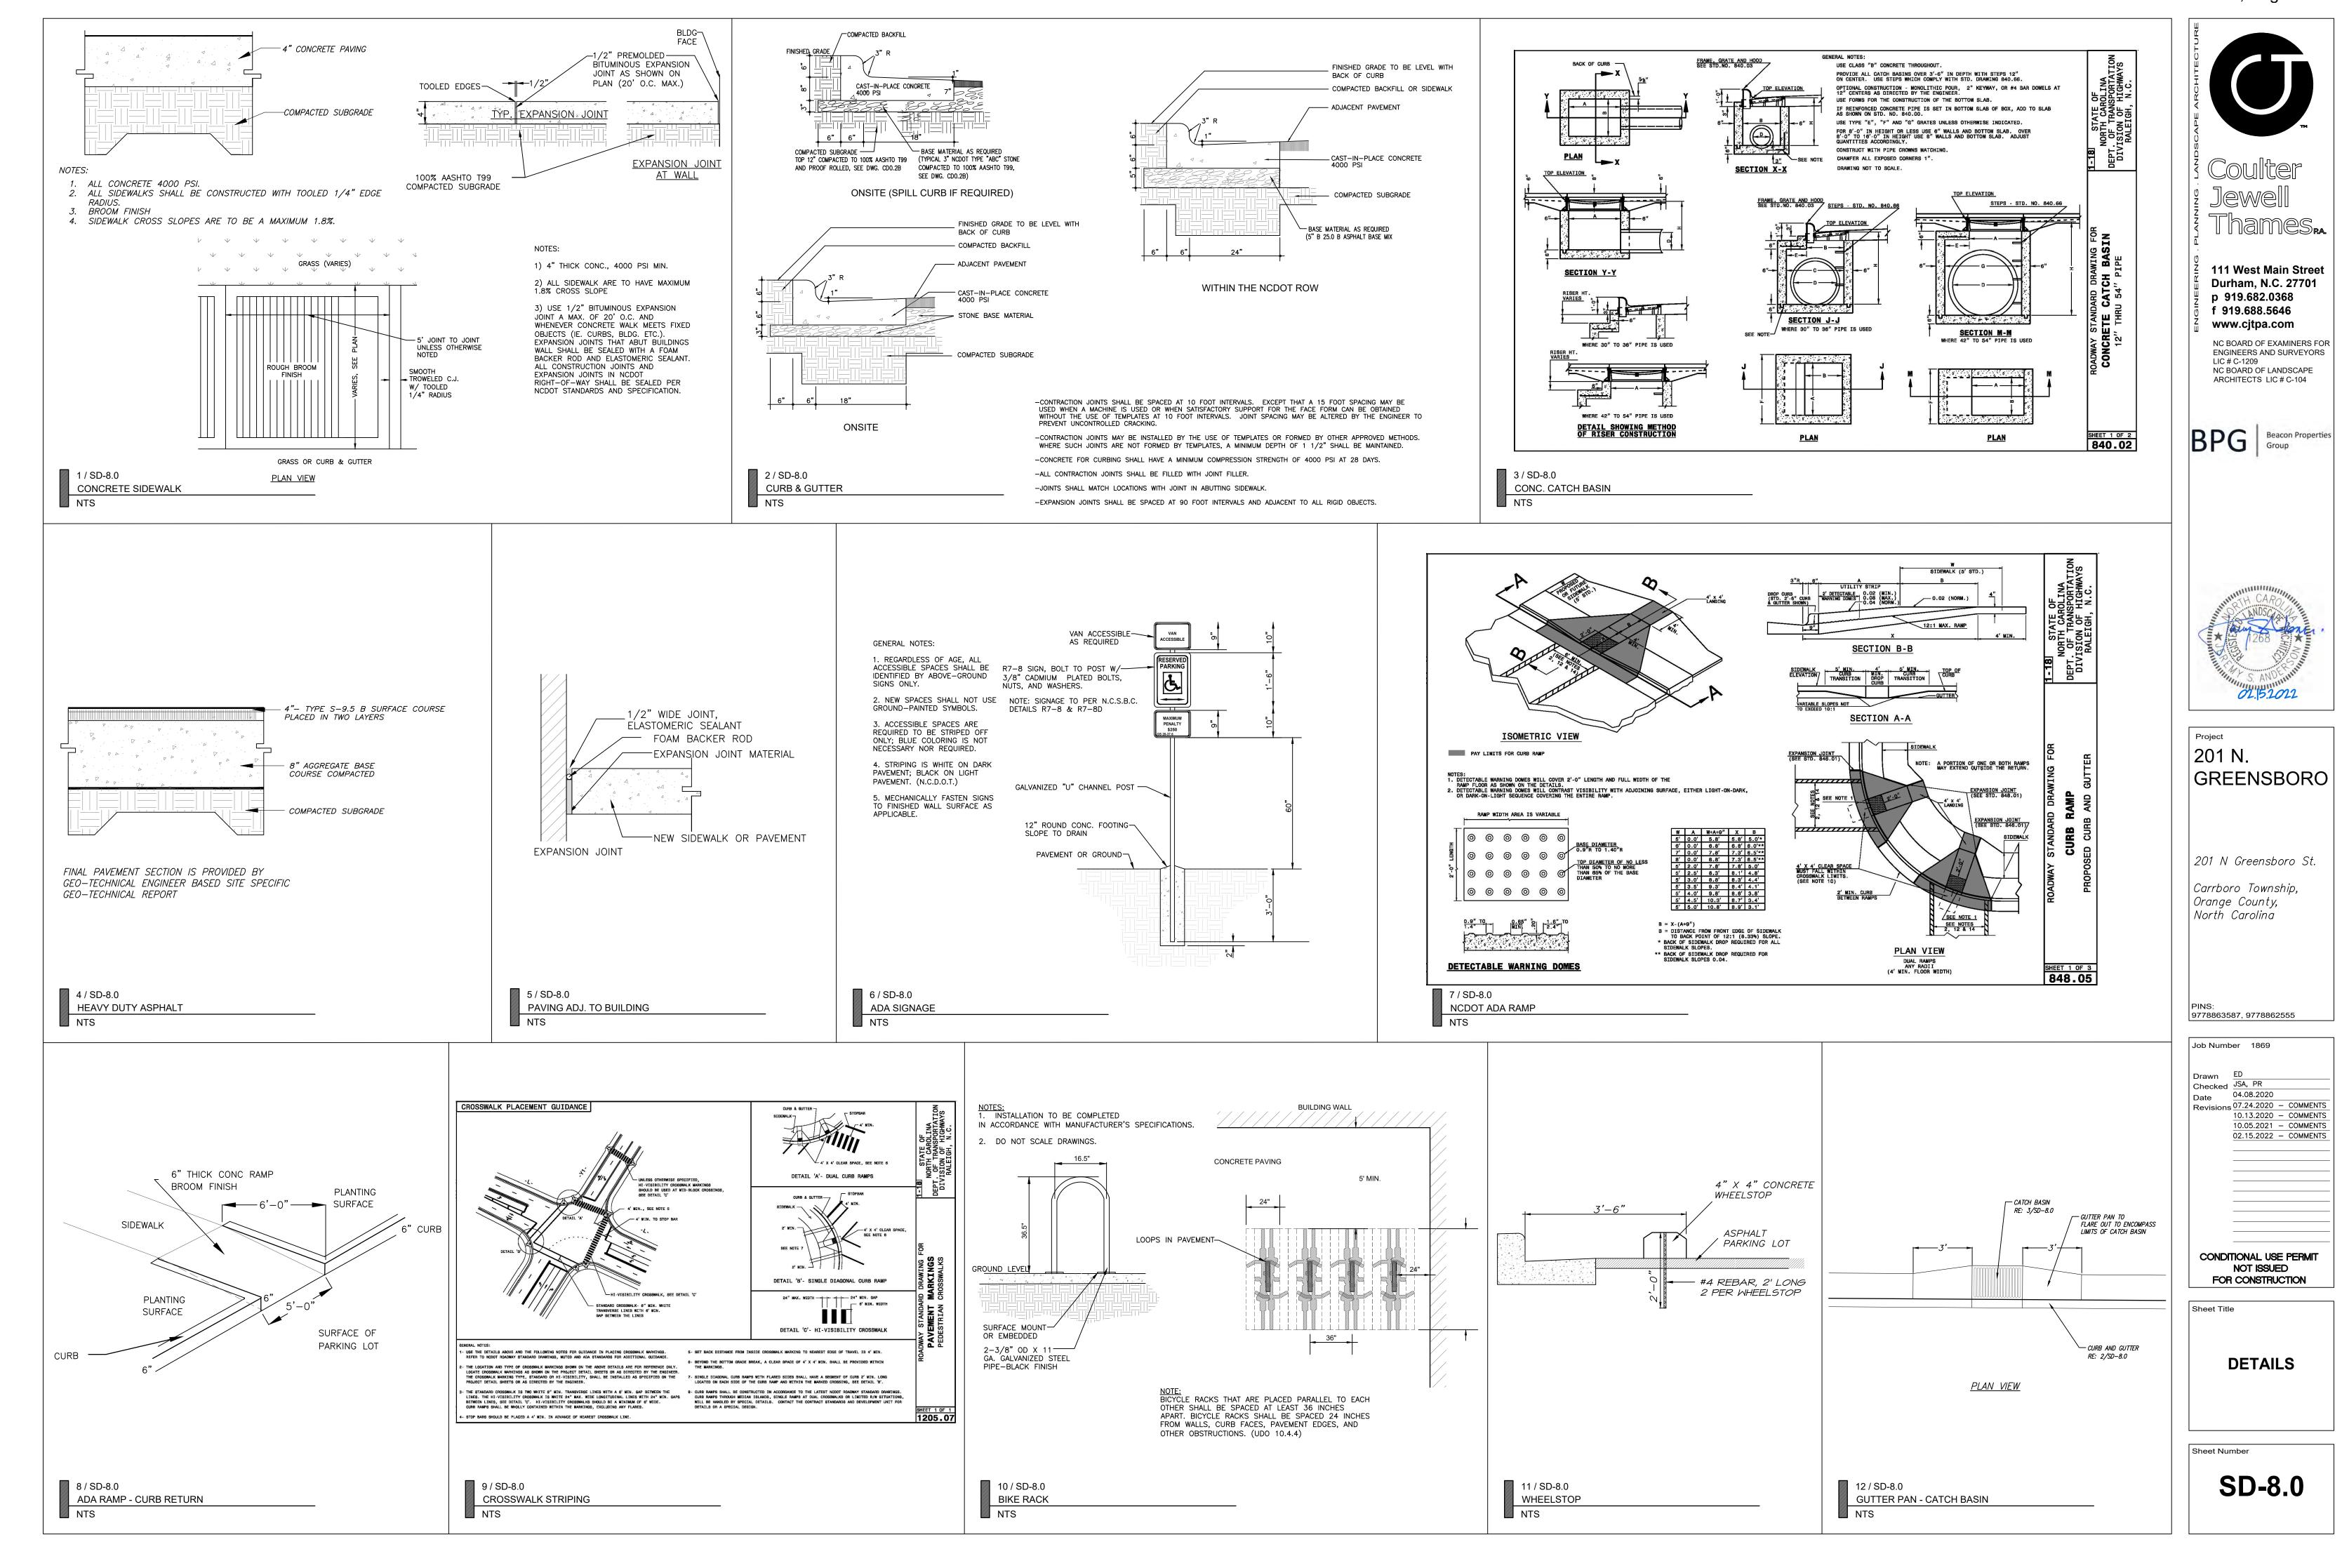
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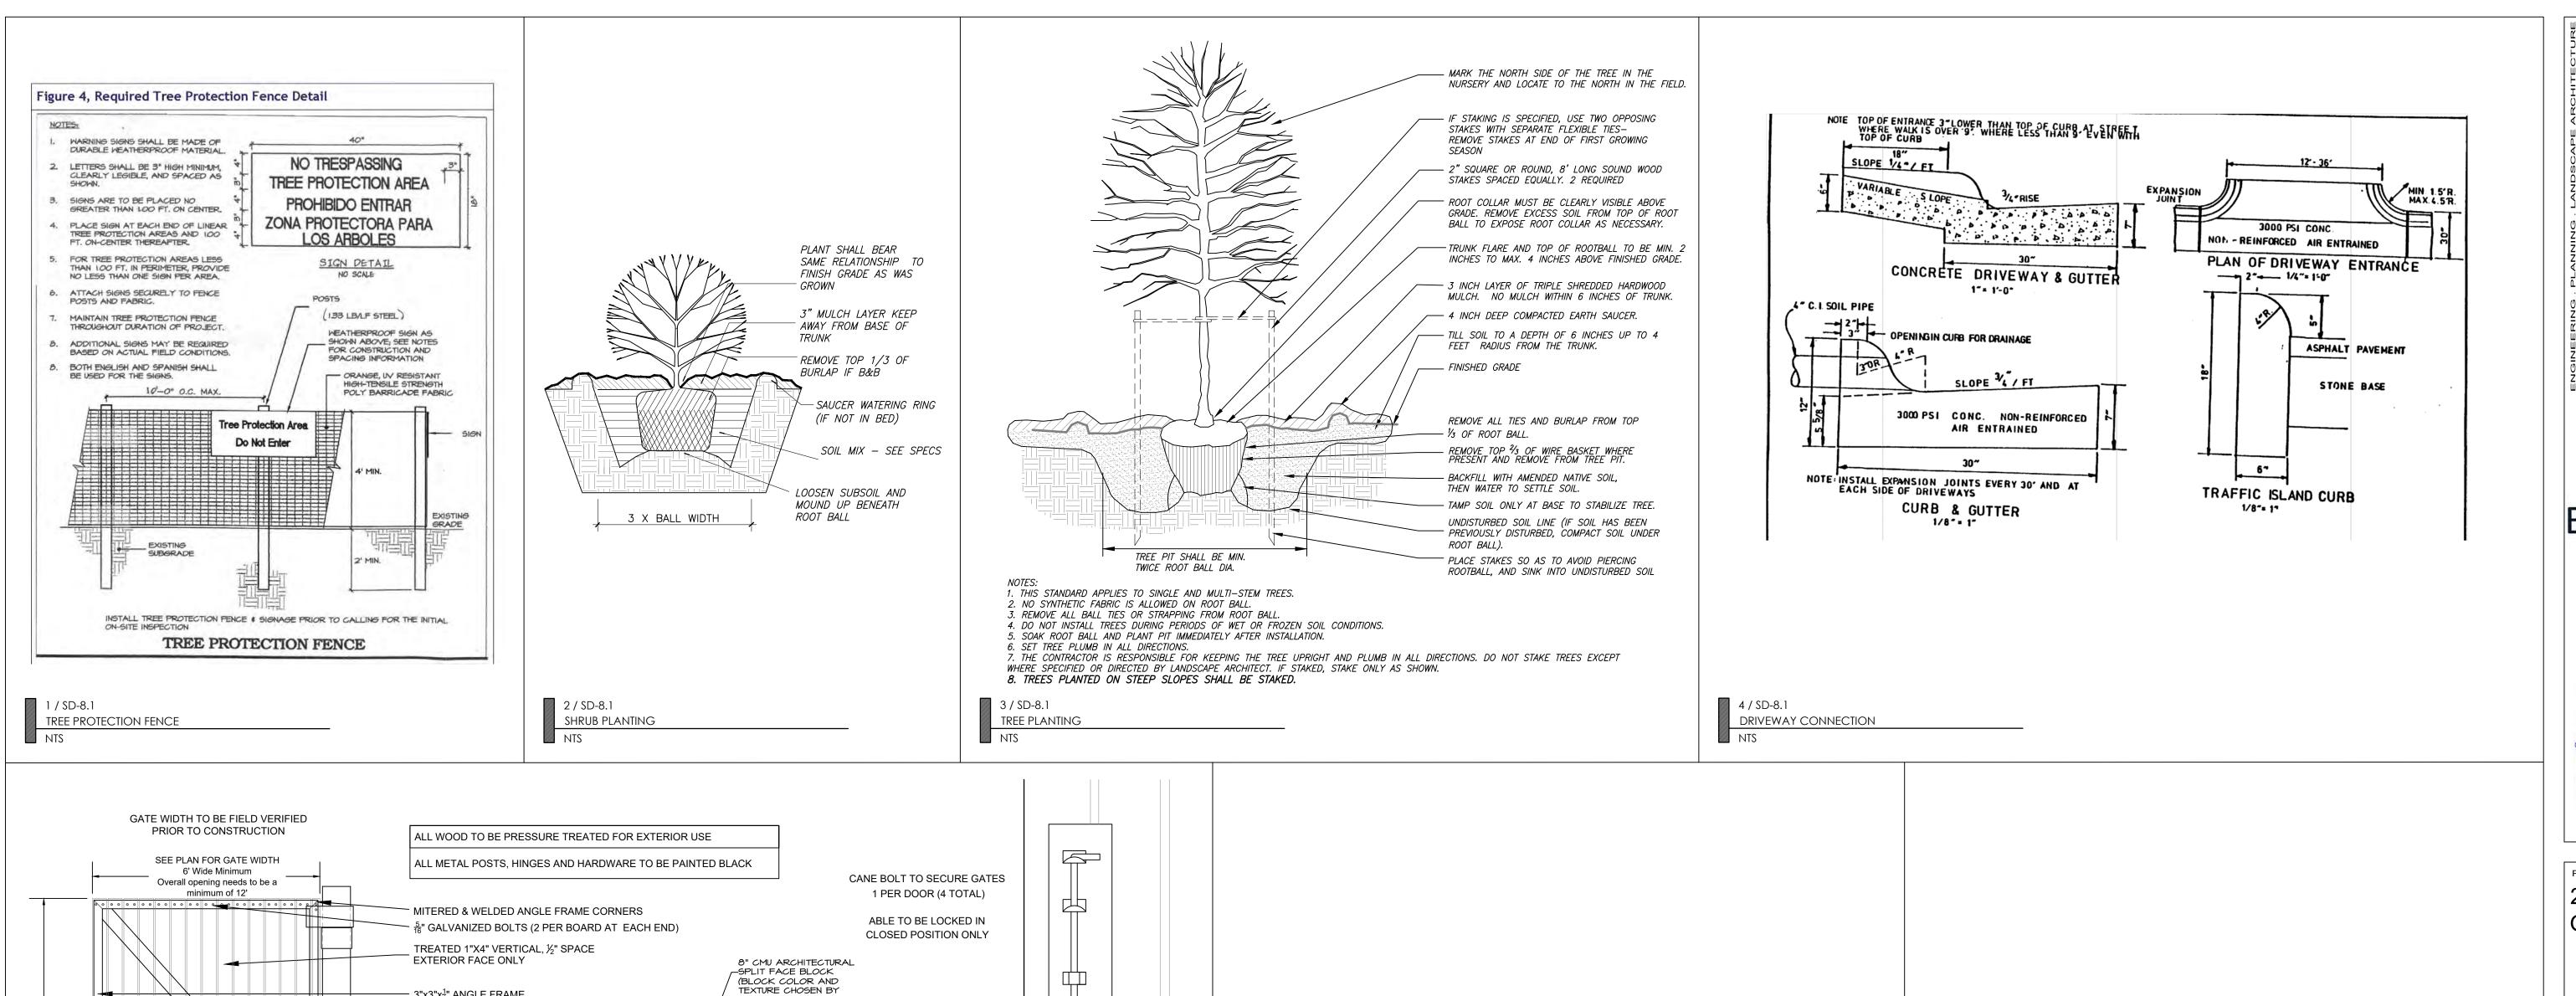
LANSCAPE **PLAN** 

Sheet Number

**SD-7.0** 

Scale 1" = 20'





-3"x3"x $\frac{1}{4}$ " ANGLE FRAME

6½" Ø PIPE SLEEVE

POST FILL W/ CONC.

CONC. FOOTING

- APPROX. 1"

6" Ø SCHEDULE 80

STEEL GALV. POST

3" TALL-TACK TO COLUMN

STEEL POST

HINGE (TYP.) 3 PER COLUMN

6" Ø SCHEDULE 80

6½" Ø PIPE SLEEVE

TACKED TO PIPE COLUMN

6½" Ø PIPE SLEEVE

HEAVY DUTY HINGE-3 PER GATE

4"x4" PLATE. WELD ENDS TO ANGLE

18" TURN DOWN PAD

6" Ø SCHEDULE 80 STEEL GALV.

TACKED TO PIPE COLUMN

7'-0"

CANE BOLT EXTERIOR FACE

OF DOOR

3/8" STIFF

TREATED 1"X4" VERTICAL \_\_\_

 $3"x3"x_4^1"$  ANGLE IRON —

5/16" GALVANIZED BOLTS

5 / SD-8.1

DUMPSTER ENCLOSURE

ON OUTSIDE FACE OF DOOR

**GATE AND PIPE COLUMN** 

3/8" STIFF

WOOD GATE W/

HINGE AND PIPE COLUMN

METAL FRAME

OWNER TO ACCENT ADJACENT BUILDINGS)

SCREEN WALL AND PAD

4" SCH. 80

-GALV. STEEL

BOLLARD

BOLLARD

**CANE BOLT** 

MASONRY CAP

#4 BARS @ 32" O.C. IN GROUT FILLED

TO MATCH WALL BLOCK

8" CMU ARCHITECTURAL

SPLIT FACE BLOCK

(BLOCK COLOR AND

ADJACENT BUILDINGS)

LADDER MESH HORIZONTAL - JOINT REINFORCEMENT EVERY

(ALTERNATE: BOND BEAM #3 @

32" O.C. CONT. WITH GROOVED

- GROUT ALL REINFORCED CELLS AND CELLS BELOW

MIN. 2' REBAR OVERLAP

-3000 PSI CONC. FOOTING

MIDDLE OF 8" CMU WALL

-3 x #4 BARS CONTINUOUS, 3"

+4 BARS @ 16"O.C., LOCATE IN

ALTERNATE HOOK DIRECTION

COMPACTED OR UNDISTURBED

NOTES:

6 / SD-8.1

NTS

PERMEABLE PAVERS

TEXTURE CHOSEN BY

OWNER TO ACCENT

BEAM BLOCKS)

FINISHED GRADE


FOOTING COVER

FINISH GRADE


8" CONCRETE PAD


SCREEN WALL SECTION

8" CONCRETE PAD COMPACTED SUBGRADE

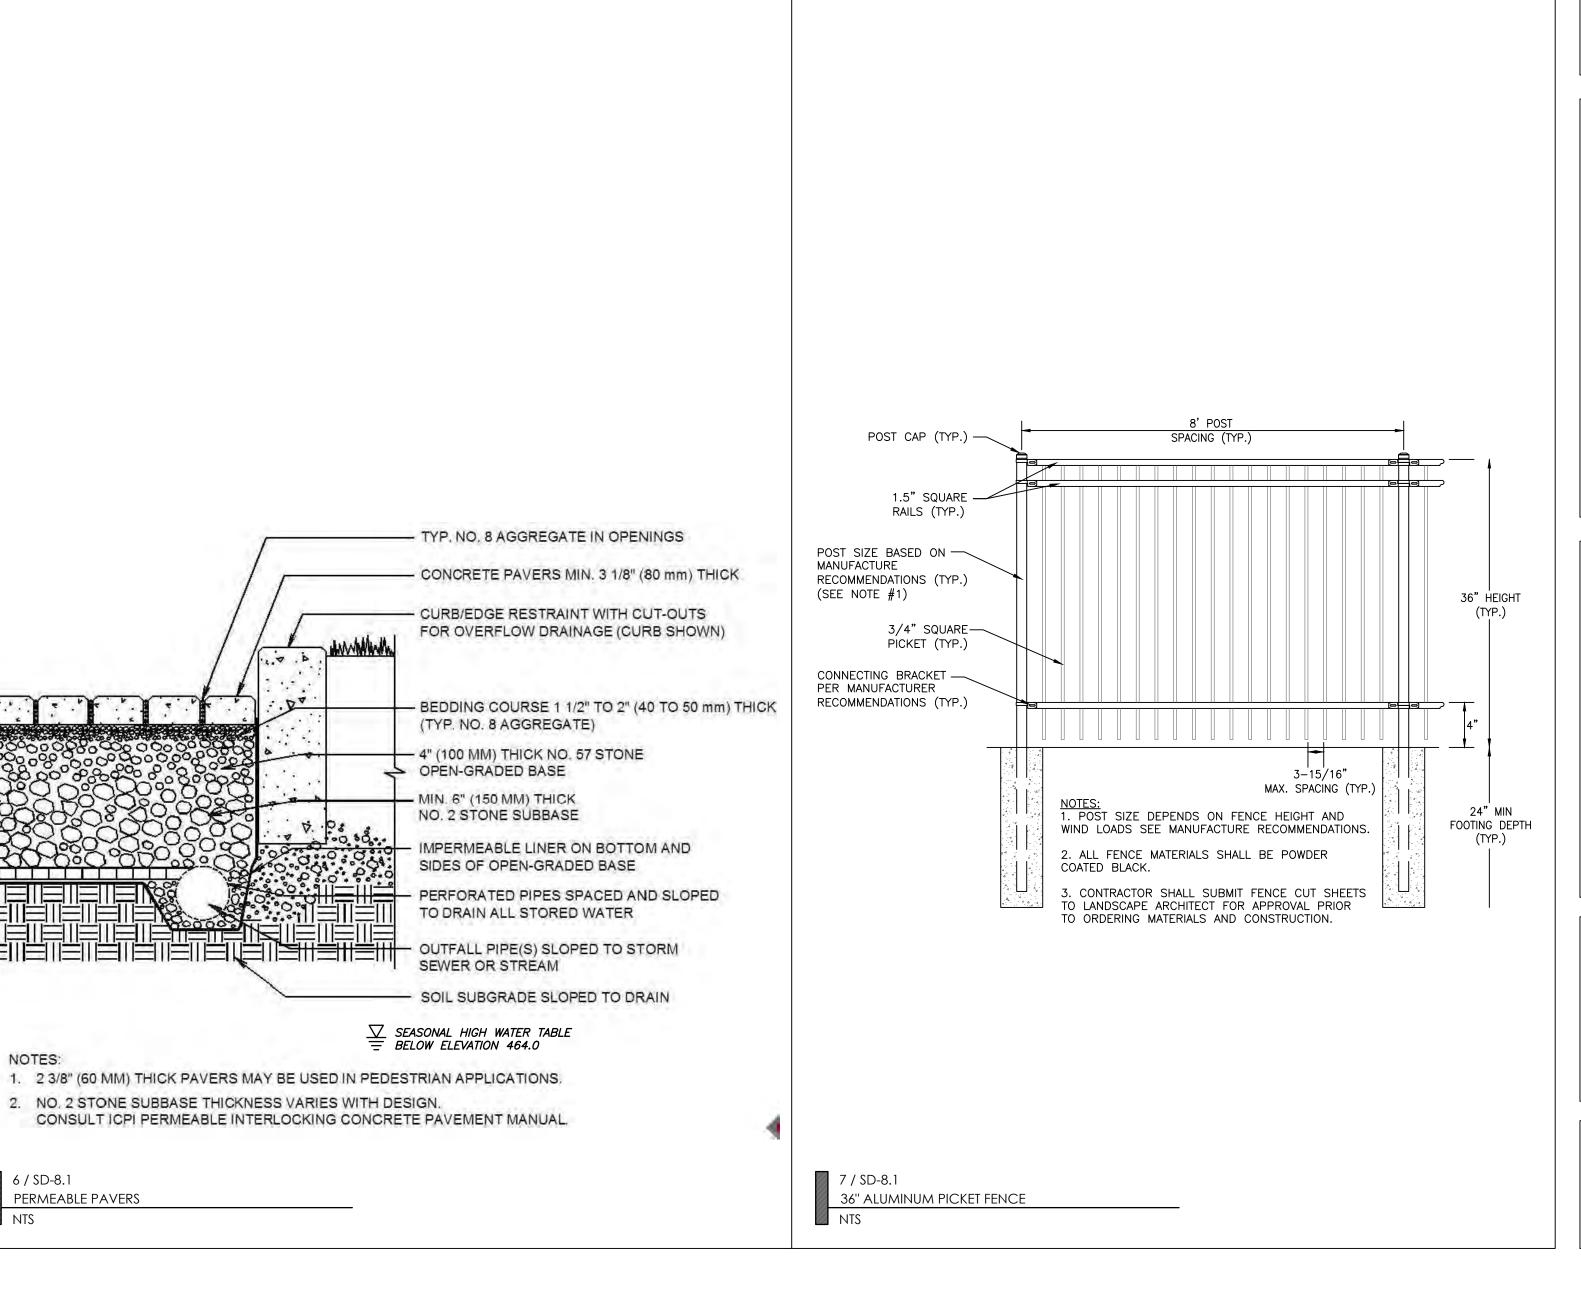



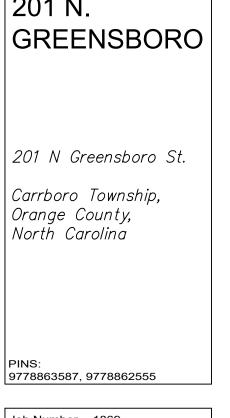

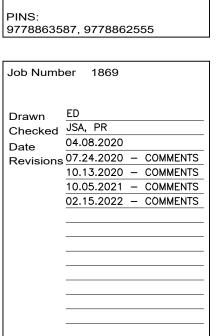




Sheet Title

**DETAILS** 

Sheet Number

**SD-8.1** 

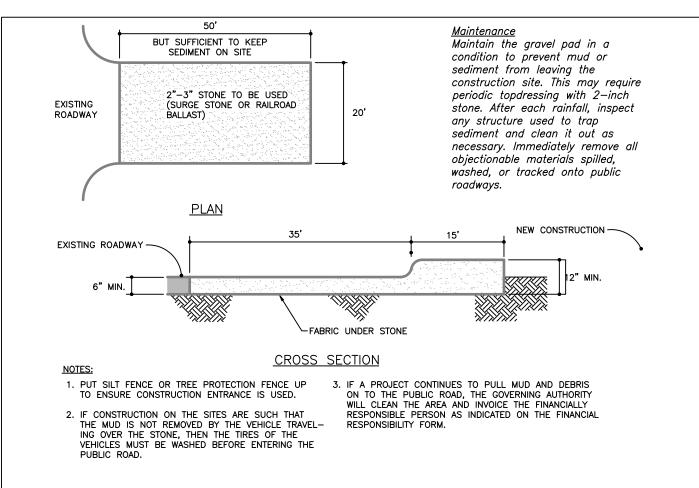

1 / SD-8.2 GRAVEL CONSTRUCTION ENTRANCE NTS

FILTER FABRIC / MONSANTO BIDIM - C34 or EQUAL HOG WIRE, 12 GAUGE MIN., 4"x4" SUPPORT FENCING -AT 8 FEET MAXIMUM SPACING NOTE: REMOVE SEDIMENT THAT ACCUMULATES IN FRONT OF FENCE. REPAIR OR REPLACE ANY DAMAGED 6" TRENCH GROUND SURFACE POSTS DRIVEN 18" INTO GROUND FABRIC FLAP ON

1. Inspect sediment fences at least once a week and after each rainfall. Make any required repairs immediately. 2. Should the fabric of a sediment fence collapse, tear, decompose or become ineffective, replace it promptly. 3. Remove sediment deposits as necessary to provide adequate storage volume for the next rain and to reduce pressure on the fence. Take care to avoid undermining the fence during cleanout. 4. Remove all fencing materials and unstable sediment deposits and bring the area to grade and stabilize it after the contributing drainage area has been properly stabilized.

2 / SD-8.2 SILT FENCE NTS

FALL/WINTER/SPRING TEMPORARY COVER AUGUST 15 - MAY 1 100 lbs/1000 sf 25 lbs/1000 sf 2 lbs/1000 sf Lime 10-10-10 Fertilizer Oat Seed Rye Grain Seed Straw Mulch \* 1 lbs/1000 sf 100 lbs/1000 sf SUMMER TEMPORARY COVER MAY 1 - AUGUST 15 Lime 10-10-10 Fertilizer 100 lbs/1000 sf 15 lbs/1000 sf 1 lbs/1000 sf 100 lbs/1000 sf Browntop Millet Seed Straw Mulch \* SPRING/FALL PERMANENT COVER MARCH 1 - APRIL 30 100 lbs/1000 sf 25 lbs/1000 sf 8 lbs/1000 sf 10-10-10 Fertilizer Improved Turf Type Fine Fescue Seed Straw Mulch \* 100 lbs/1000 sf SUMMER PERMANENT COVER APRIL1 - AUGUST 15

BERMUDAGRASS BERMUDAGRASS(HYBRID) CENTIPDEGRASS ST.AUGISTINEGRASS TALL FESCUE

ZOYSIAGRASS OPTIMUM DATE OF PLANTING. SEEDING BEYOND THESE DATES INCREASES THE CHANCE OF FAILURE.

2. POUNDS PER 1000 SQ.FT. 3. BUSHELS PER 1000 SQ.FT Seedbed Preparation: Remove rocks, stumps, roots, etc. Apply lime and fertilizer then rip the soil 4 to 6 inches to mix the nutrients into the soil and to loosen and roughen it to recieve seed.

Seed Temporary cover to stabilize temporary sedimentation control measures and other accomplished. If planting season is not suitable for installation of permanent cover. Contractor shall install temporary cover suitable for that season and reseed with permanent grass at earliest possible date. \* Anchor straw mulch by applying an asphalt binder emulsion at a rate of 10 gallons per 1000 SF, or install jute, paper or twine netting or excelsior mats staked to ground according to the manufacturer's instructions.

3 / SD-8.2

NTS

SEEDING SCHEDULE

STABILIZATION TIME TABLE

1. All permanent dikes, swales, ditches, perimeter slopes, and all slopes steeper than 3:1 shall be provided with temporary or permanent stabilization with groundcover as soon as practicable but within 7 calendar days from last land-disturbing activity. 2. All other disturbed areas shall be provided with temporary or permanent stabilization with groundcover as soon

"EXPOSED" AREAS INCLUDE, BUT ARE NOT LIMITED TO: AREAS CLEARED FOR ROADWAY CONSTRUCTION.

AREAS CLEARED ON RESIDENTIAL BUILDING LOTS.


as practicable but in any event within 14 calendar days from last land-disturbing activity.

•	DRAINAGE EASEMEN IS AND OPEN DRAINAGE CHANNELS.
•	SEDIMENT AND EROSION CONTROL MEASURES (SEDIMENT TRAPS, DIVERSION DITCHES, ETC.)
	AND THE AREAS ADJECENT TO SUCH MEASURES.

Ground Stabilization*					
Site Area Description	Stabilization Time Frame	Stabilization Time Frame Exceptions			
Perimeter dikes, swales, ditches, and slopes	7 days	None			
High Quality Water (HQW) Zones	7 days	None			
Slopes steeper than 3:1	7 days	None			
Slopes 3:1 or flatter	7 days	None			
All other areas with slopes flatter than 4:1	7 days	None			


\* "Extensions of time may be approved by the permitting authority based on weather or other site-specific conditions that make compliance impracticable" (Section 11.B(2)(b))

> 4 / SD-8.2 INLET PROTECTION - TYPE 1 NTS

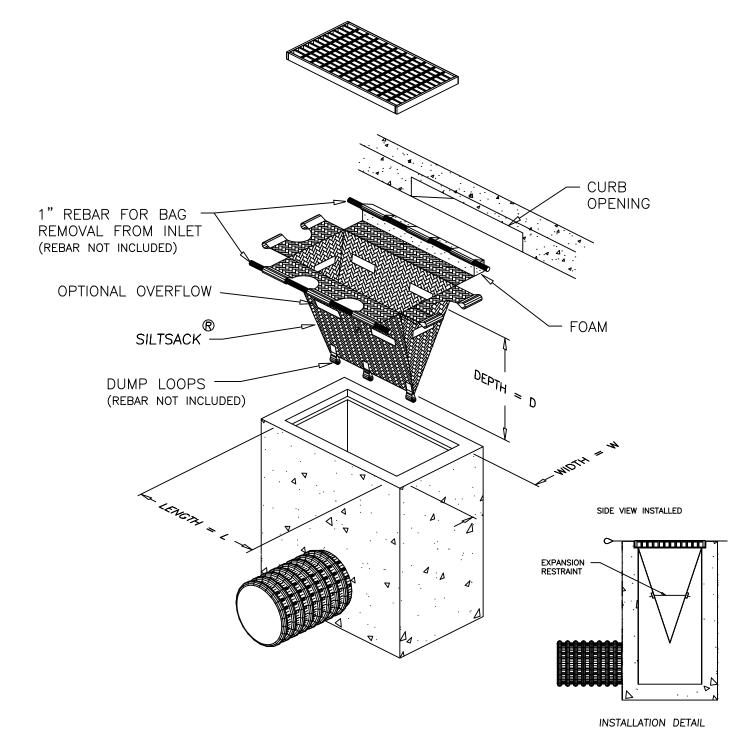

Inspect inlets at least weekly and after each significant (½ inch or greater) rainfall event. Clear the mesh wire of any debris or other objects to provide adequate flow for subsequent rains. Take care not to damage or undercut the wire mesh during sediment removal. Replace stone as needed.


INLET WNCDOT #5 OR #57 WASHED STONE

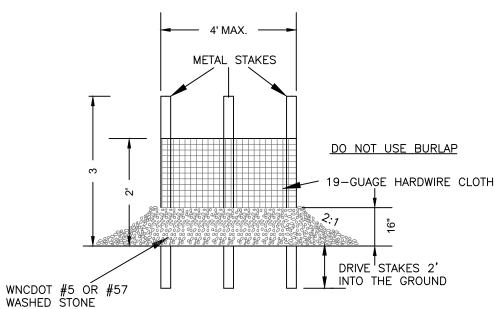


CONSTRUCTION SPECIFICATIONS 1. Uniformly grade a shallow depression approaching the inlet. 2. Drive 5-foot steel posts 2 feet into the ground surrounding the inlet. Space posts evenly around the perimeter of the inlet, a maximum of 4 feet apart. 3. Surround the posts with wire mesh hardware cloth. Secure the wire mesh to the steel posts at the top, middle, and bottom. Placing a 2-foot flap of the wire mesh under the gravel for anchoring is recommended.


4. Place clean gravel (NC DOT #5 or #57 stone) on a 2:1 slope with a height of 16 inches around the wire, and smooth to an even grade. 5. Once the contributing drainage area has been stabilized, remove accumulated sediment, and establish final grading elevations. 6. Compact the area properly and stabilized it with groundcover.

4 / SD-8.2 INLET PROTECTION - TYPE 2 NTS

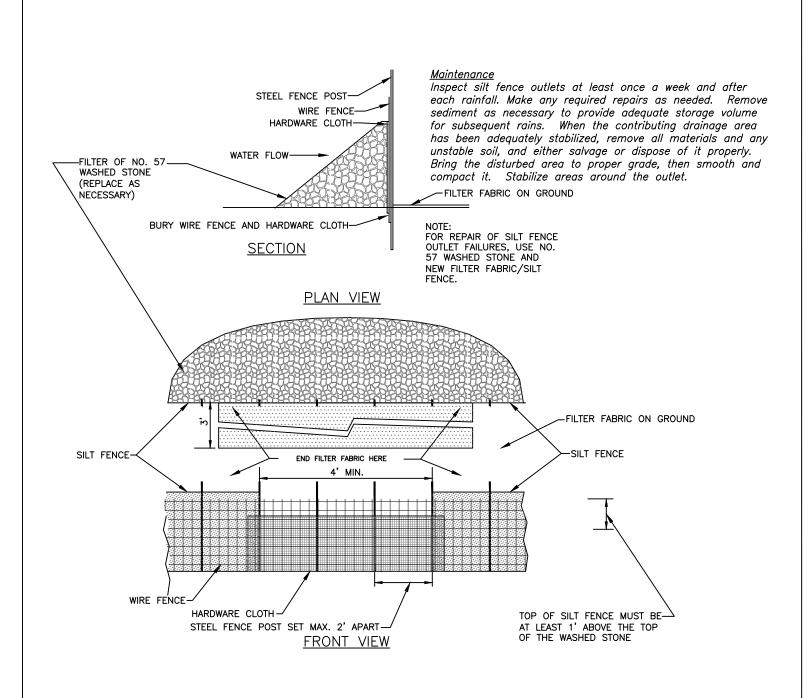



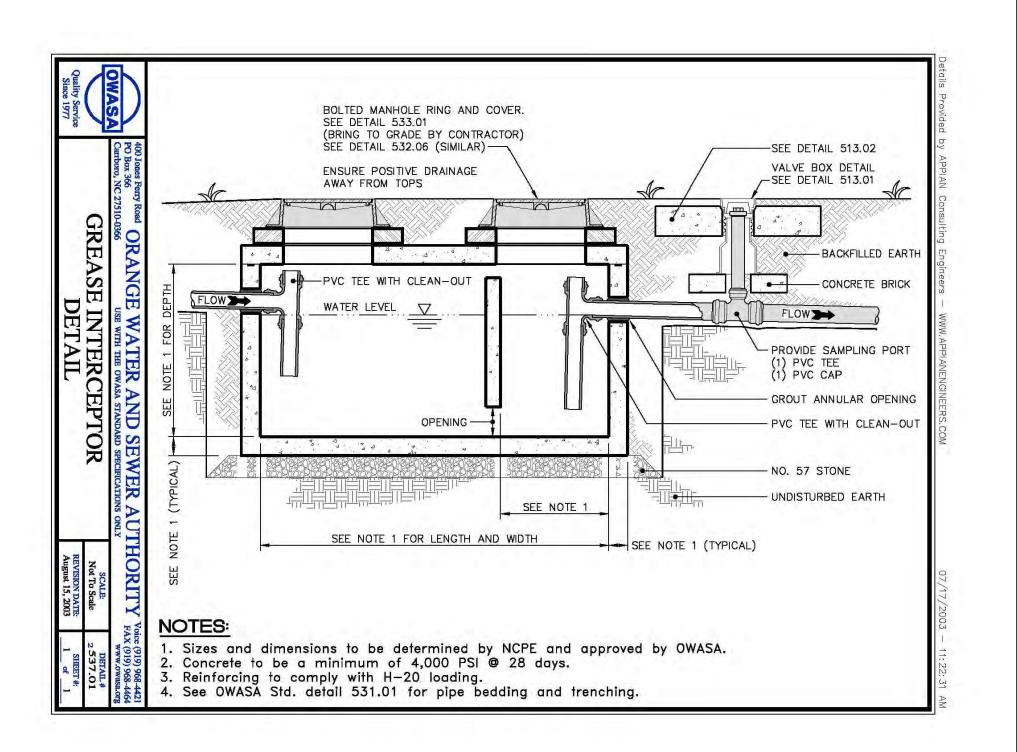

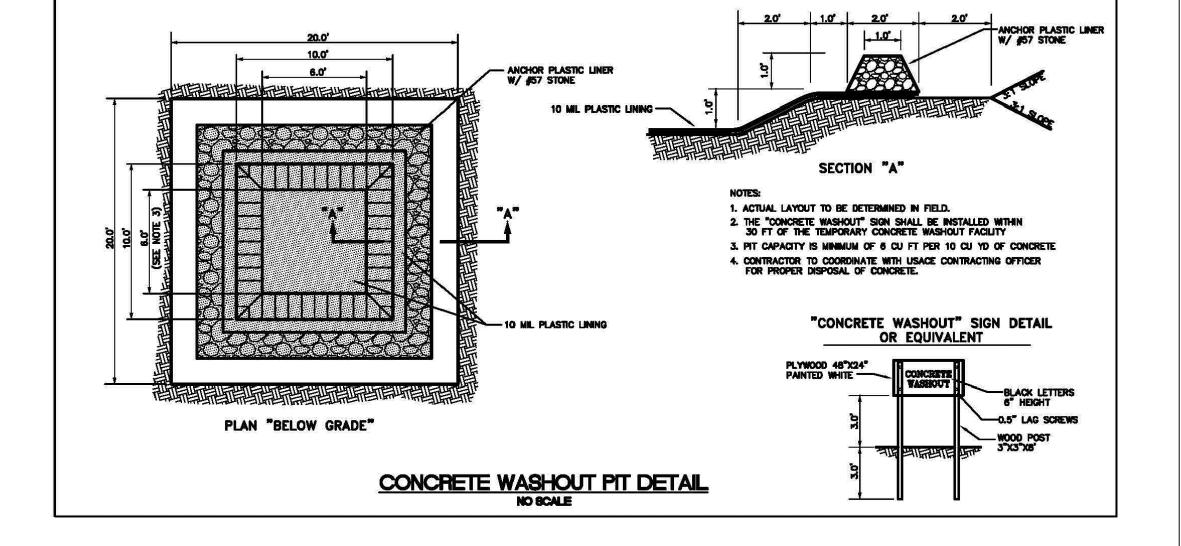

7 / SD-8.2 CONCRETE WASH OUT

111 West Main Street Durham, N.C. 27701 p 919.682.0368

NC BOARD OF EXAMINERS FOR ENGINEERS AND SURVEYORS LIC # C-1209 NC BOARD OF LANDSCAPE ARCHITECTS LIC # C-104

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Project **GREENSBORO** 

201 N Greensboro St. Carrboro Township,

Orange County, North Carolina

9778863587, 9778862555 Job Number 1869 Drawn ED Checked JSA, PR 04.08.2020 Revisions 07.24.2020 - COMMENTS 10.13.2020 - COMMENTS 10.05.2021 - COMMENTS 02.15.2022 - COMMENTS

CONDITIONAL USE PERMIT NOT ISSUED FOR CONSTRUCTION

Sheet Title

**DETAILS** 

Sheet Number

**SD-8.2** 



CONSTRUCTION

019092 05/27/2021 DATE

A2.0